
Nottingham Hills Subdivision 6 Lot Re-Subdivision of Lot 32 A Conservation Design Development (CDD)

Reference Maps

- "NOTTINGHAM HILLS SUBDIVISION PHASE 3 NIANTIC REAL ESTATE, LLC, EAST LYME, CONNECTICUT" PREPARED BY J ROBERT PFANNER & ASSOCIATES P.C. DATED AUGUST 1, 2005 SCALE 1"=60"

- 8. "LOT LINE REVISION PLAN NOTTINGHAM HILLS SUBDIVISION LOTS 26, 27 & 28 PREPARED FOR: ENGLISH HARBOUR ASSET MANAGEMENT LLC PREPARED BY GESICK & ASSOCIATES P.C. DATED JANUARY 24, 2020 REVISED THRU AUGUST 2, 2021 SCALES PAGES 1 & 4 = 1"=50' PAGES 2 & 3 = 1"=40'

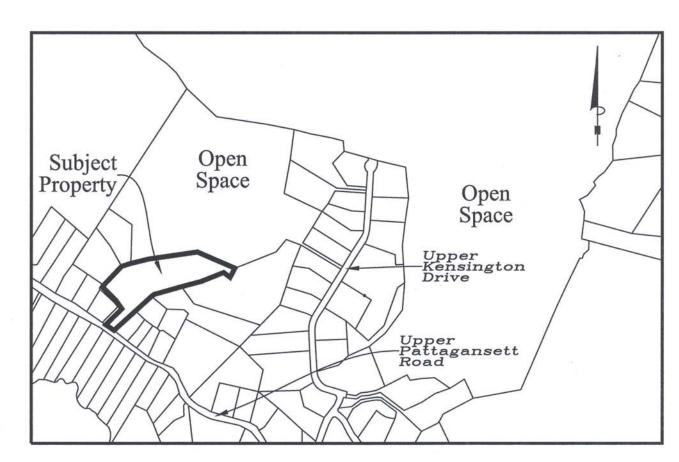

Location Map

Scale: 1"=800'

Sheet Index Sheet 1 - Title Sheet
Sheets 2 & 3 - Existing Conditions Survey
Sheets 4 & 5 - Subdivision Plan & Site Plan Sheets 6, 7 & 8 - Details

1) THIS SURVEY PLAN HAS BEEN PREPARED PURSUANT TO THE REGULATIONS OF CONNECTICUT STATE AGENCIES SECTION 20-300B-1 THROUGH 20-300B-20 AND THE "STANDARDS FOR SURVEYS AND MAPS IN THE STATE OF CONNECTICUT" AS ADOPTED BY THE CONNECTICUT ASSOCIATION OF THE LAND SURVEYORS, INC. ON OCTOBER 26, 2018. A. TYPE OF SURVEY: TOPOGRAPHIC SURVEY.

B. WITH RESPECT TO THE PERIMETER OF THE PROPERTY THE BOUNDARY DETERMINATION IS BASED UPON A RESURVEY OF REFERENCE MAP #1. C. THIS SURVEY CONFORMS TO THE STANDARDS AND THE ACCURACY OF CLASS: A-2 HORIZONTAL & T-2 TOPOGRAPHIC ACCURACY. D. BEARINGS AS DEPICTED ARE BASED UPON THE CONNECTICUT GRID SYSTEM NORTH AMERICAN DATUM OF 1983

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2) BOUNDARY LINES OF ADJOINING PROPERTIES ARE SHOWN FOR GENERAL INFORMATIONAL PURPOSES ONLY AND ARE NOT TO BE CONSTRUED AS BEING ACCURATELY LOCATED OR DEPICTED.

3) THE WORD "CERTIFY" AS USED IS UNDERSTOOD TO BE AN EXPRESSION OF PROFESSIONAL OPINION BY THE SURVEYOR. IT IS A DECLARATORY STATEMENT, WHICH IS BASED ON HIS BEST KNOWLEDGE, INFORMATION AND BELIEF. AS SUCH IT CONSTITUTES NEITHER GUARANTEE NOR WARRANTY, EXPRESSED OR IMPLIED, OF ANY INFORMATION CONTAINED HEREON. NO CERTIFICATION IS EXPRESSED OR IMPLIED ON ANY ORIGINAL OR ANY DUPLICATE OF THIS MAP UNLESS IT BEARS AN ORIGINAL STAMP OR SEAL AND ORIGINAL SIGNATURE OF THE INDIVIDUAL WHOSE REGISTRATION NUMBER APPEARS HEREON.

4) THIS MAP IS THE PROPERTY OF GESICK & ASSOCIATES P.C. AND HAS BEEN SPECIFICALLY PREPARED FOR THE OWNER OF THIS PROJECT OR PROPERTY. IT IS NOT TO BE DUPLICATED OR USED IN PART OR WHOLE FOR ANY OTHER PURPOSE, PROJECT, LOCATION, OR OWNER WITHOUT THE EXPRESS WRITTEN CONSENT OF GESICK & ASSOCIATES P.C.

5) KRISTEN CLARKE IS THE INDIVIDUAL RESPONSIBLE INSTALLATION, MONITORING AND CORRECTION OF ALL EROSION AND SEDIMENTATION CONTROL

6) UTILITY EASEMENT DEPICTED ON SHEETS 4&5 IS TAKEN FROM REFERENCE MAP #3 AND ALSO RECORDED IN THE EAST LYME LAND RECORDS DRAWER 6 #441 AND VOLUME 794 PAGE 510.


7) LOTS 32, 32.1, 32.2, 32.3. 32.4, & 32.5 SHARE A COMMON DRIVEWAY & UTILITY EASEMENT AS IS IDENTIFIED IN THESE PLANS. A MAINTENANCE AGREEMENT FOR THIS COMMON DRIVEWAY WILL BE RECORDED IN THE LAND RECORDS OF THE TOWN OF EAST LYME SIMULTANEOUSLY WITH THE MYLARS

8) WELL AND SEPTIC LOCATIONS / LAYOUT PROVIDED BY KRISTEN CLARKE P.E. MANAGER, ENGLISH HARBOUR ASSET MANAGEMENT LLC. PER DISCUSSIONS WITH LEDGE LIGHT HEALTH DISTRICT.

9) PURSUANT TO THE TOWN OF EAST LYME, CONNECTICUT SUBDIVISION REGULATIONS SECTIONS 6-10-3 (D) & (E) THE COMMON DRIVEWAY IDENTIFIED IN THESE PLANS WILL NOT BE OWNED BY THE TOWN OF EAST LYME. ALL MAINTENANCE, REPAIR, AND SERVICES SUCH AS SNOW REMOVAL, SANDING, AND SWEEPING OF THE COMMON DRIVEWAY WILL BE THE RESPONSIBILITY OF THE ABUTTING LANDOWNERS. THE TOWN OF EAST LYME SHALL NOT BE RESPONSIBLE FOR THE INITIAL COST, MAINTENANCE FEES, OR UTILITY BILLS ASSOCIATED WITH ALL STREET SIGN OR STREET LIGHTS LOCATED ON THE COMMON DRIVEWAY OR ADJACENT TO AND SERVING THE COMMON

APPROVED BY T	HE EAST LYME PLANNING COMMISSION
Chairman / Secretary	
Approval Date	
Filling Dateline	
Expiration Date	



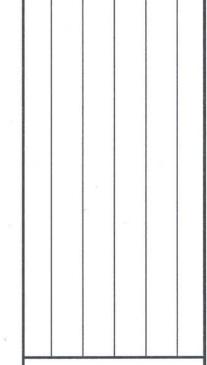


ASSOCIATES, MAPPERS & PLANNER SEDAR ISLAND AVE. GESICK

Revisions 8/12/2025 - Revised Per Comments 9/3/2025 - Revised Per Comments

Date: January 17th, 2025 Drawing: 23-005h

rawn: P.H.

1 of 7

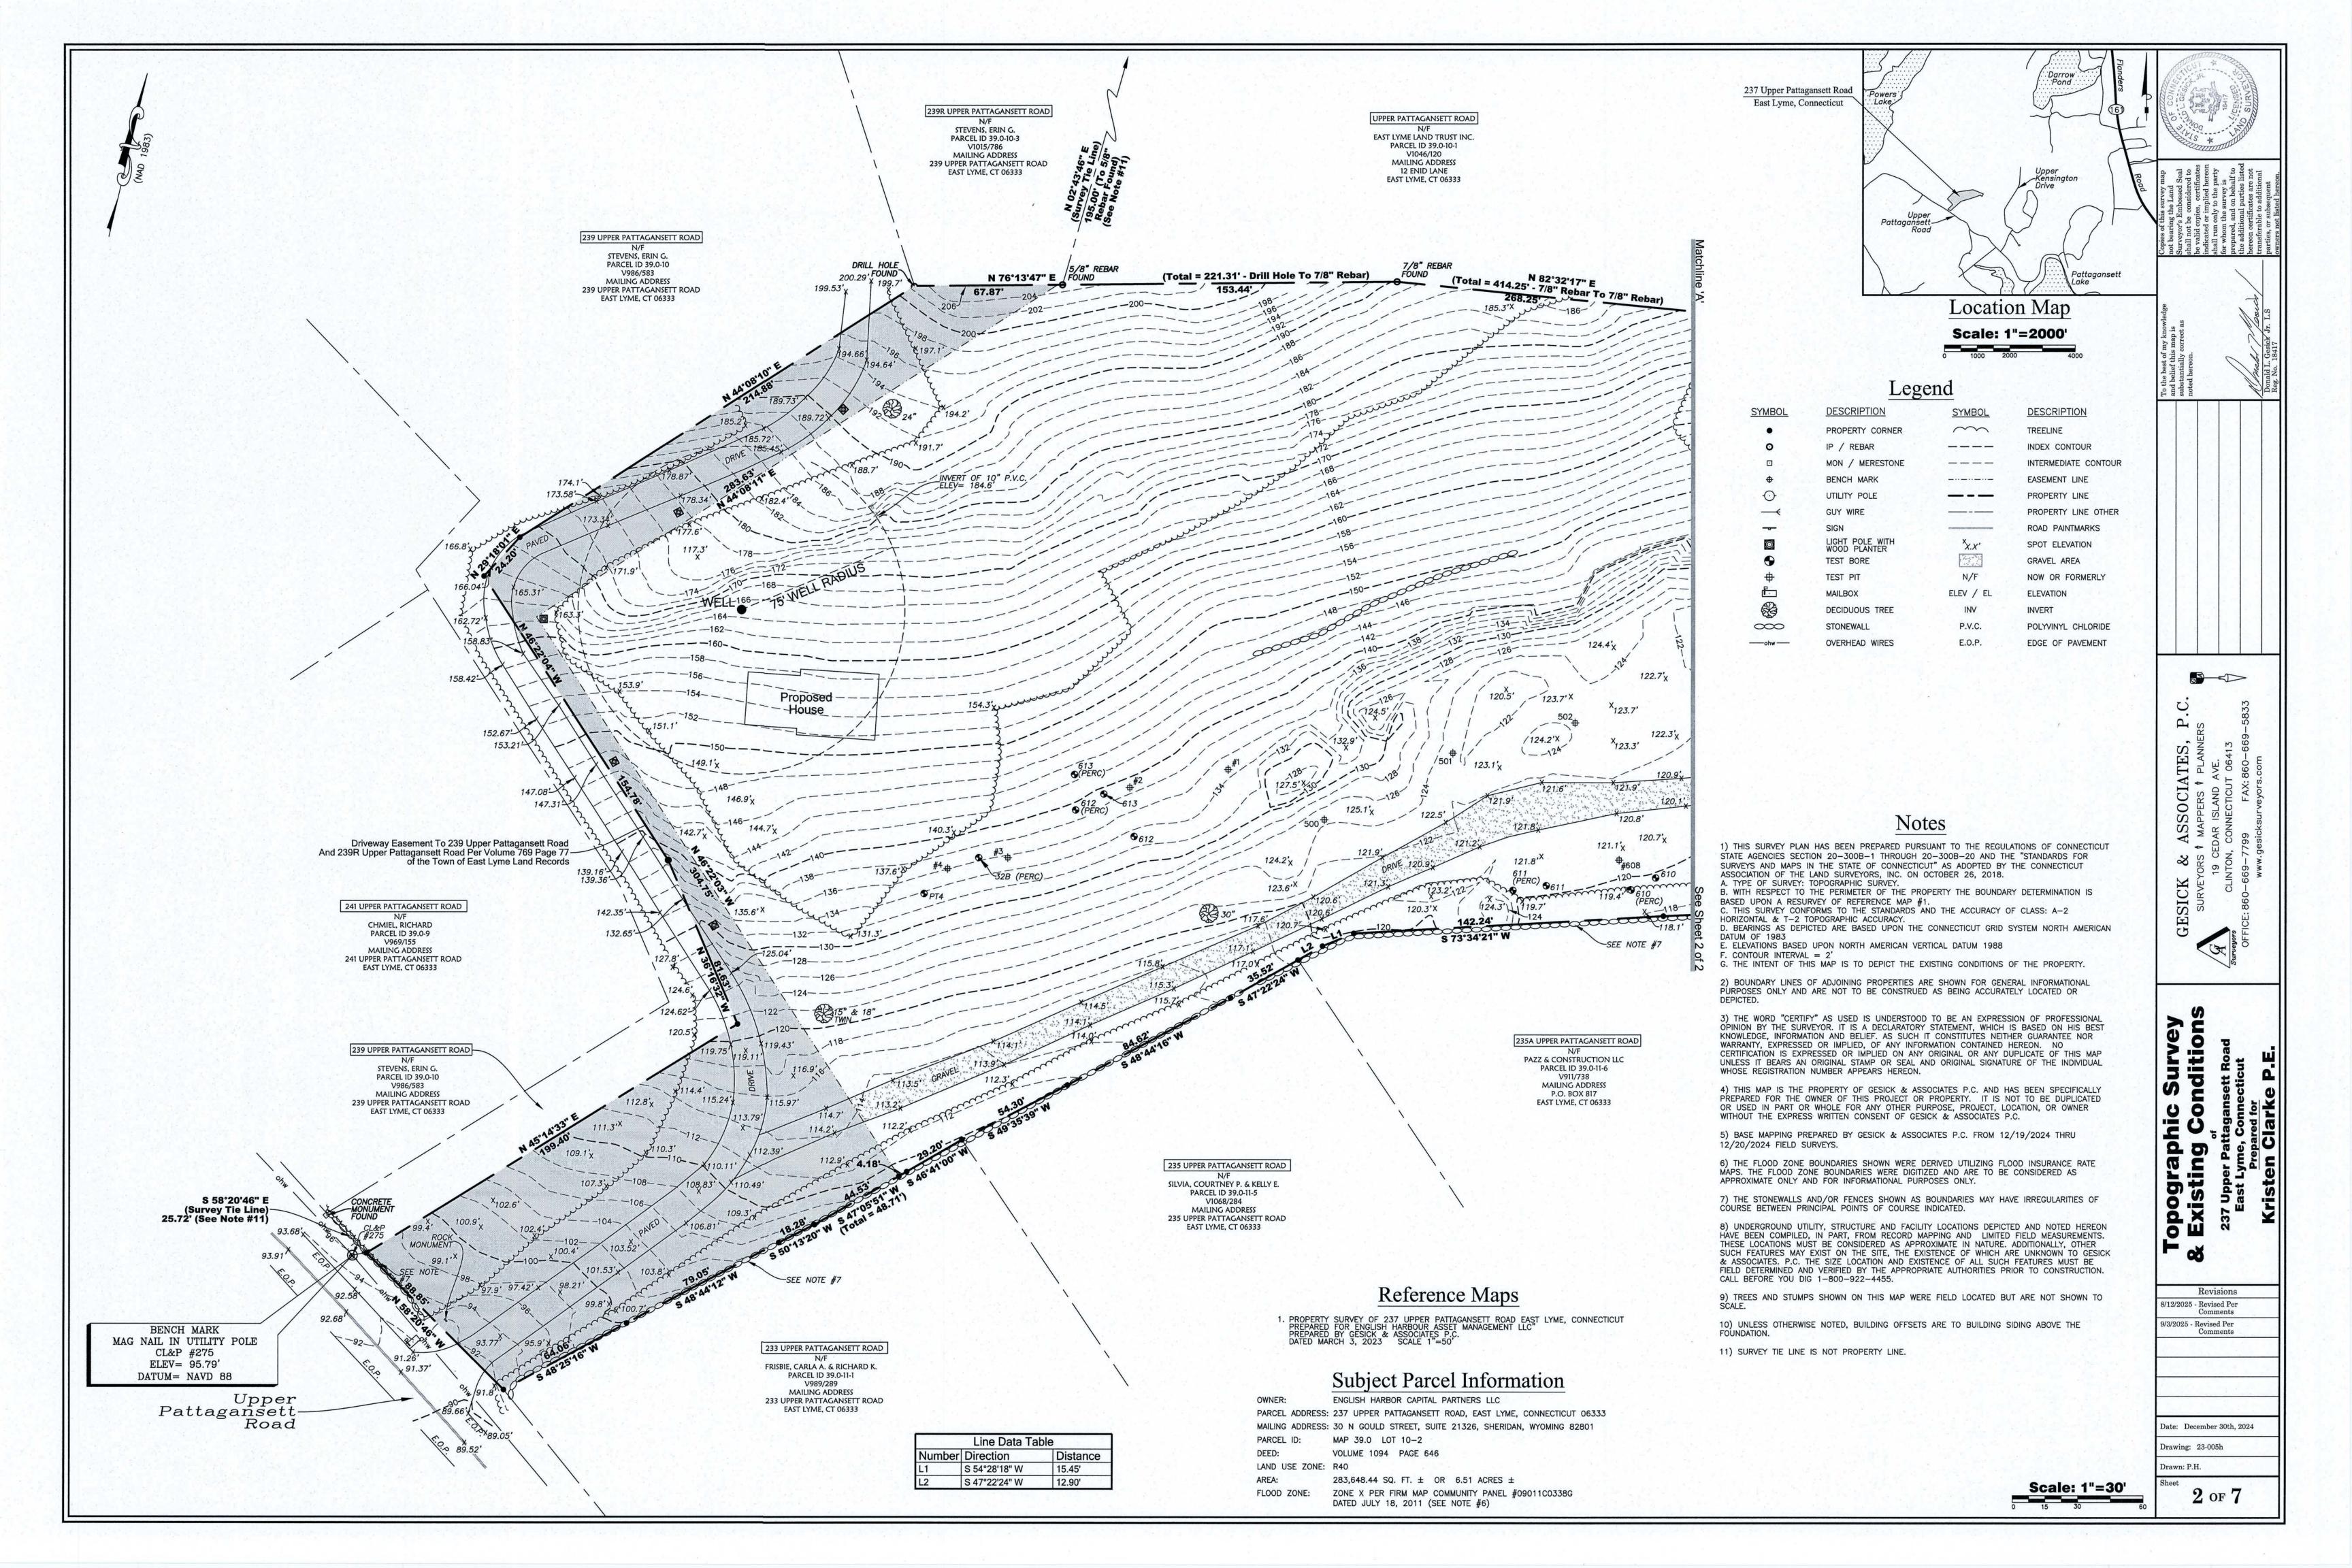

Legend

SYMBOL	DESCRIPTION	SYMBOL	DESCRIPTION
•	PROPERTY CORNER	~~	TREELINE
0	IP / REBAR		INDEX CONTOUR
	MON / MERESTONE		INTERMEDIATE CONTOUR
•	BENCH MARK		EASEMENT LINE
0	UTILITY POLE		PROPERTY LINE
\rightarrow	GUY WIRE		PROPERTY LINE OTHER
-	SIGN		ROAD PAINTMARKS
©	LIGHT POLE	*x.x*	SPOT ELEVATION
•	TEST BORE		GRAVEL AREA
+	TEST PIT	N/F	NOW OR FORMERLY
r i	MAILBOX	ELEV / EL	ELEVATION
	DECIDUOUS TREE	INV	INVERT
∞	STONEWALL	P.V.C.	POLYVINYL CHLORIDE
ohw	OVERHEAD WIRES	E.O.P.	EDGE OF PAVEMENT

Notes

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5) BASE MAPPING PREPARED BY GESICK & ASSOCIATES P.C. FROM 12/19/2024 THRU 12/20/2024 FIELD SURVEYS.

6) THE FLOOD ZONE BOUNDARIES SHOWN WERE DERIVED UTILIZING FLOOD INSURANCE RATE MAPS. THE FLOOD ZONE BOUNDARIES WERE DIGITIZED AND ARE TO BE CONSIDERED AS APPROXIMATE ONLY AND FOR INFORMATIONAL PURPOSES ONLY.


7) THE STONEWALLS AND/OR FENCES SHOWN AS BOUNDARIES MAY HAVE IRREGULARITIES OF COURSE BETWEEN PRINCIPAL POINTS OF COURSE INDICATED.

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9) TREES AND STUMPS SHOWN ON THIS MAP WERE FIELD LOCATED BUT ARE NOT SHOWN TO

10) UNLESS OTHERWISE NOTED, BUILDING OFFSETS ARE TO BUILDING SIDING ABOVE THE FOUNDATION.

11) SURVEY TIE LINE IS NOT PROPERTY LINE.

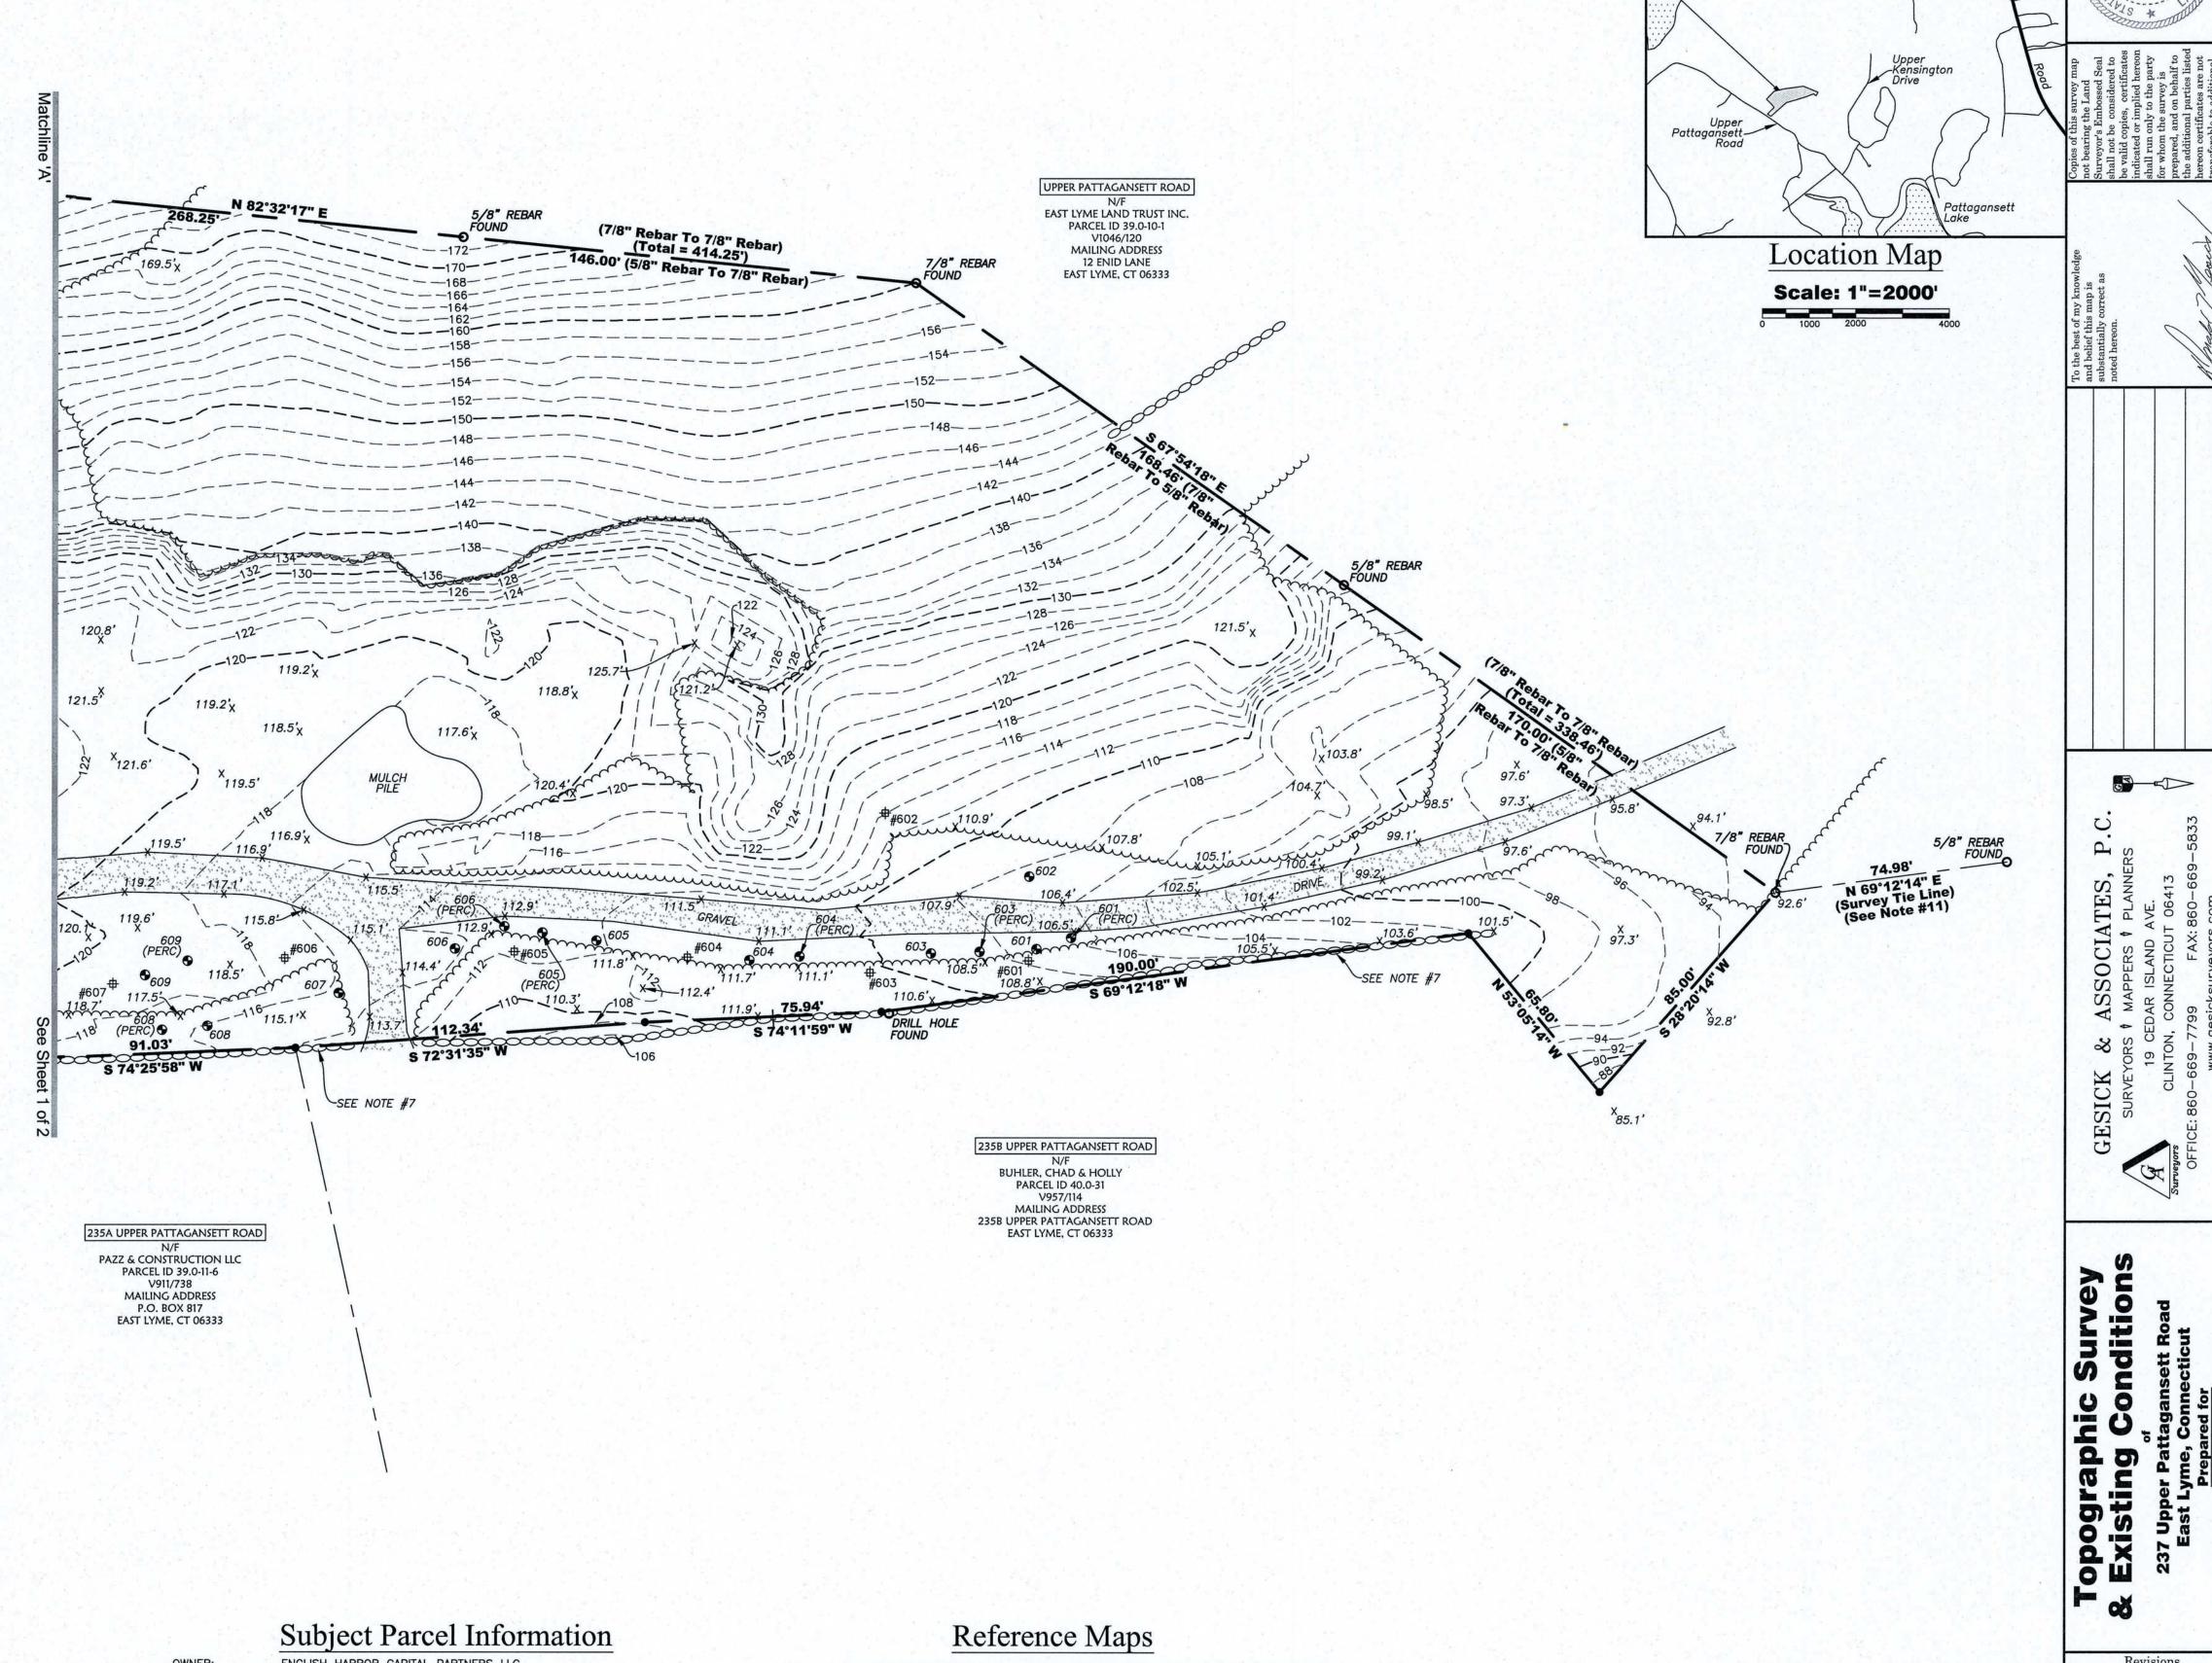

237 Upper Pattagansett Road East Lyme, Connecticut

ENGLISH HARBOR CAPITAL PARTNERS LLC PARCEL ADDRESS: 237 UPPER PATTAGANSETT ROAD, EAST LYME, CONNECTICUT 06333 MAILING ADDRESS: 30 N GOULD STREET, SUITE 21326, SHERIDAN, WYOMING 82801 PARCEL ID: MAP 39.0 LOT 10-2 DEED: VOLUME 1094 PAGE 646 LAND USE ZONE: R40 283,648.44 SQ. FT. ± OR 6.51 ACRES ± ZONE X PER FIRM MAP COMMUNITY PANEL #09011C0338G

DATED JULY 18, 2011 (SEE NOTE #6)

PROPERTY SURVEY OF 237 UPPER PATTAGANSETT ROAD EAST LYME, CONNECTICUT PREPARED FOR ENGLISH HARBOUR ASSET MANAGEMENT LLC" PREPARED BY GESICK & ASSOCIATES P.C. DATED MARCH 3, 2023 SCALE 1"=50"

opographic Survey Existing Conditions

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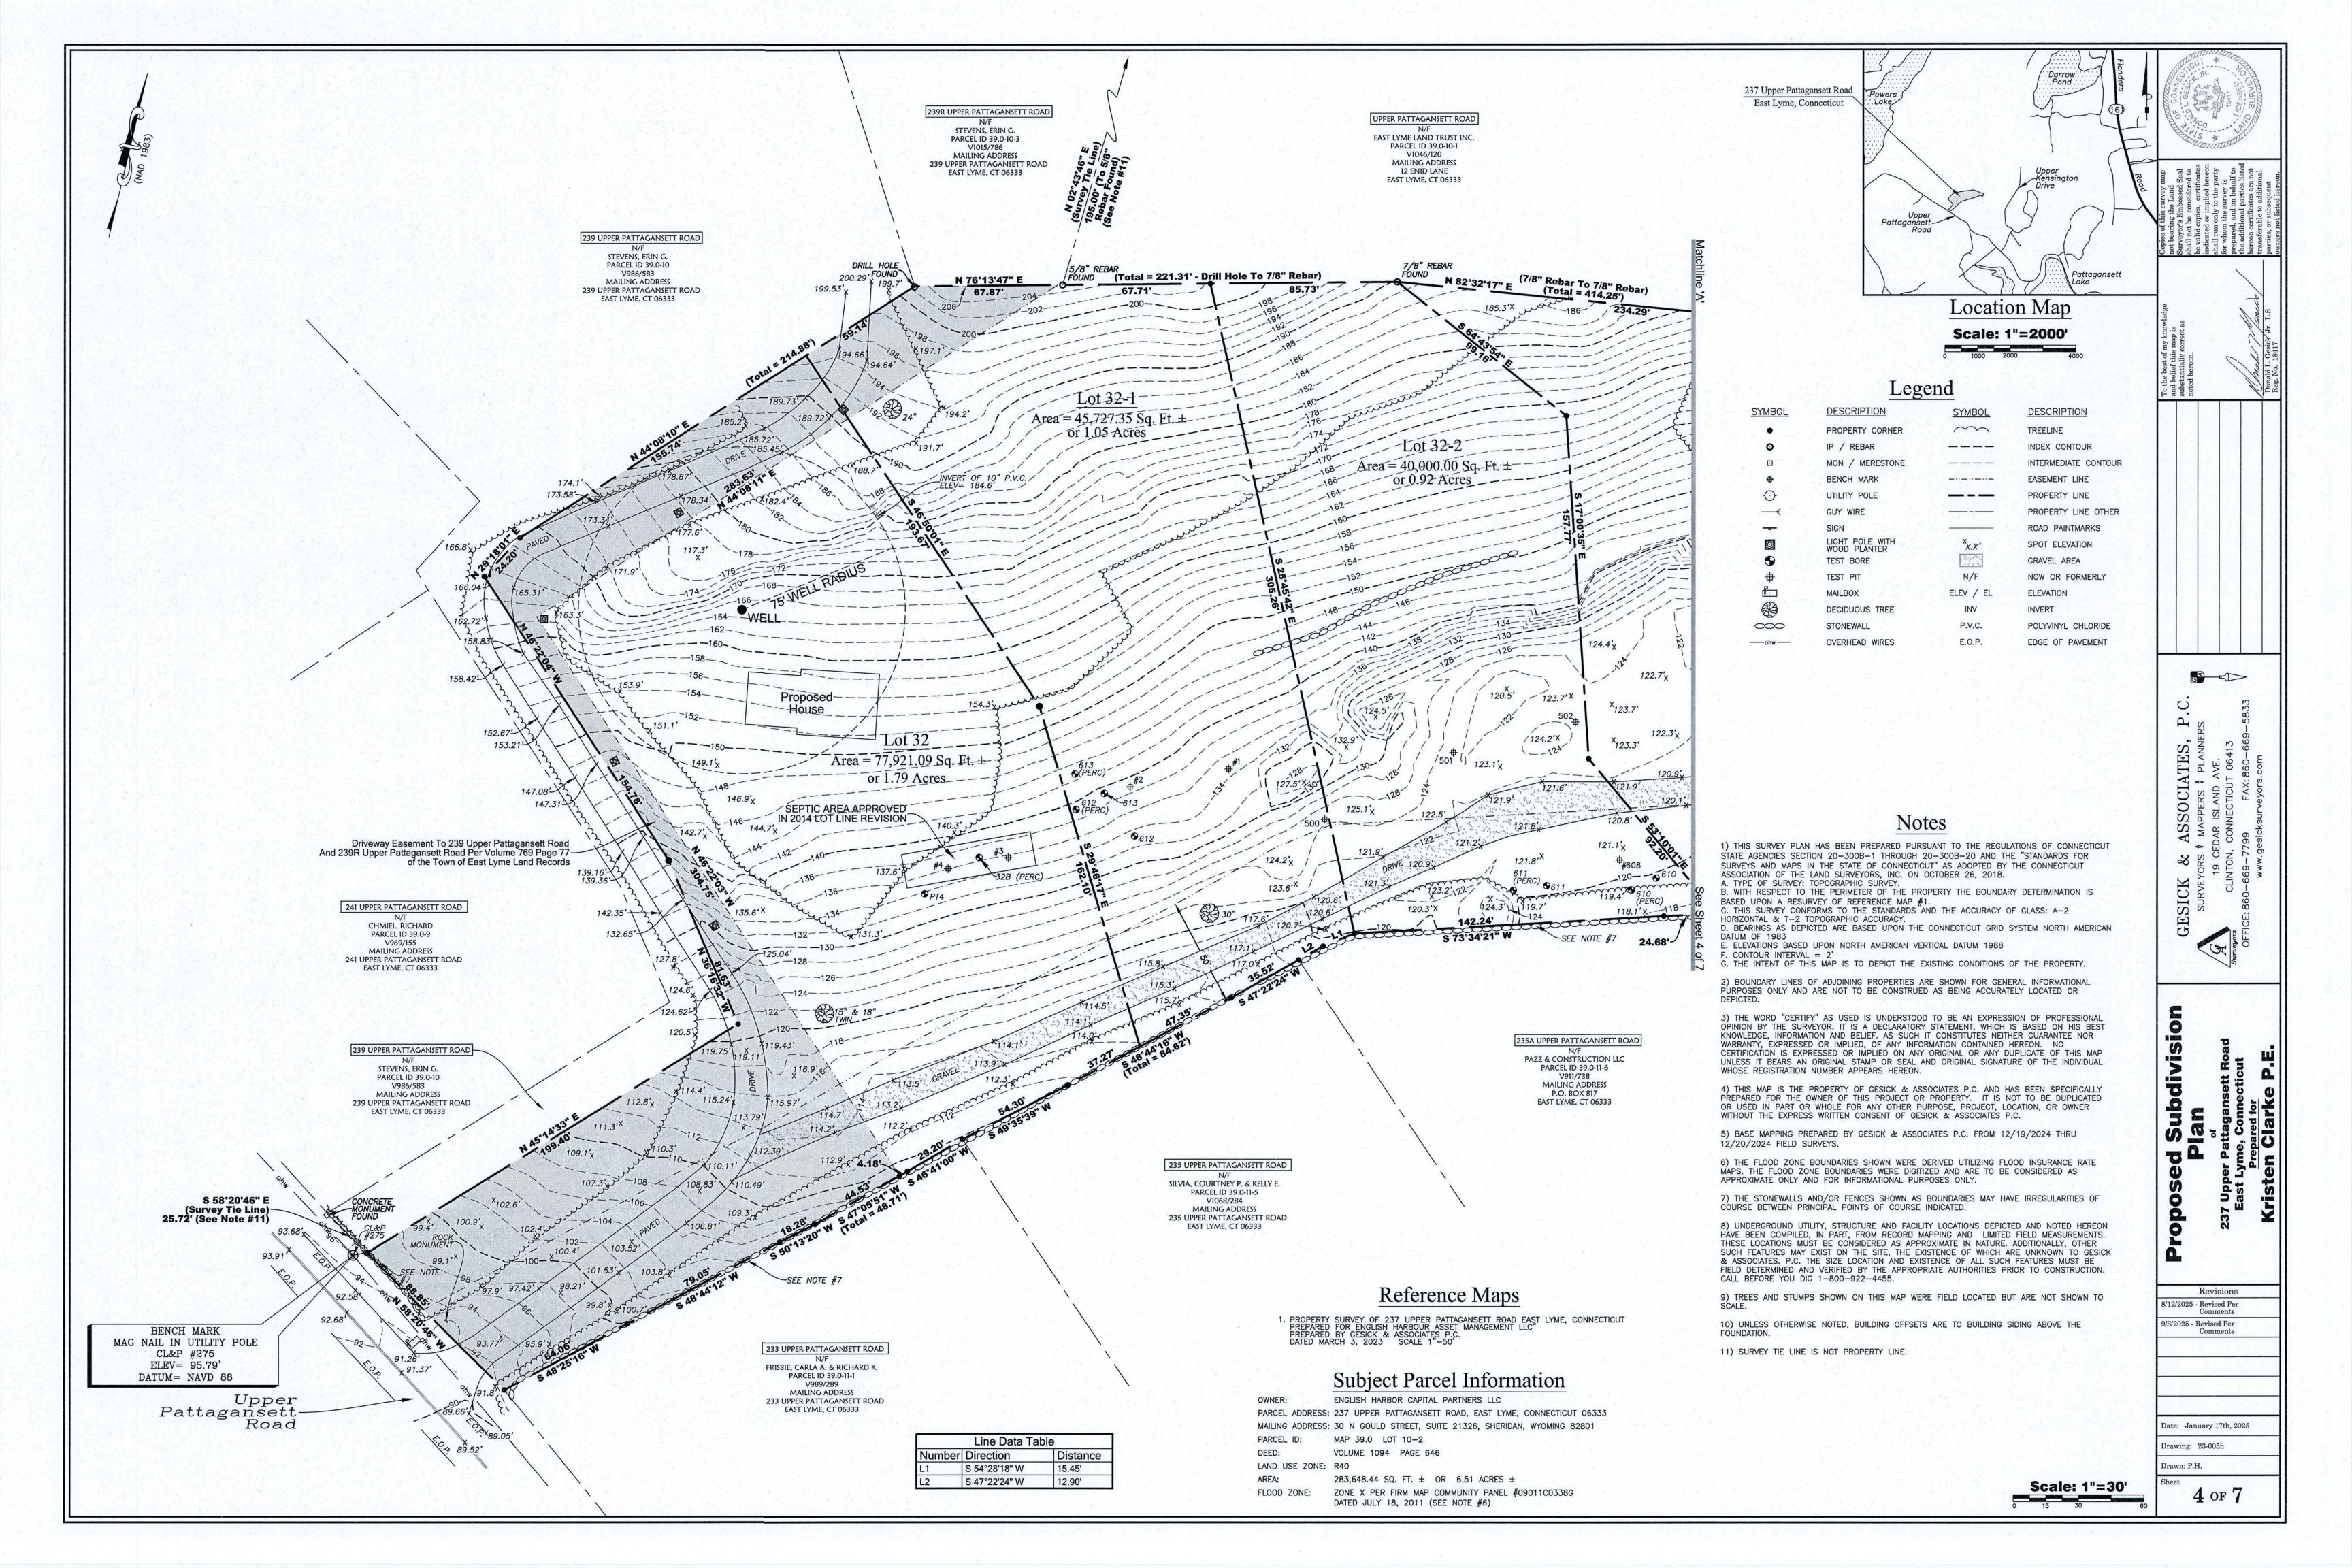
Revisions 8/12/2025 - Revised Per Comments 9/3/2025 - Revised Per Comments

Date: December 30th, 2024 Drawing: 23-005h

Drawn: P.H.

3 of 7

Scale: 1"=30'





Legend

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0	IP / REBAR		INDEX CONTOUR
	MON / MERESTONE		INTERMEDIATE CONTOUR
•	BENCH MARK	1 4	EASEMENT LINE
\odot	UTILITY POLE		PROPERTY LINE
─	GUY WIRE		PROPERTY LINE OTHER
	SIGN	and the second second	ROAD PAINTMARKS
©	LIGHT POLE	<i>x.x</i> [,]	SPOT ELEVATION
•	TEST BORE		GRAVEL AREA
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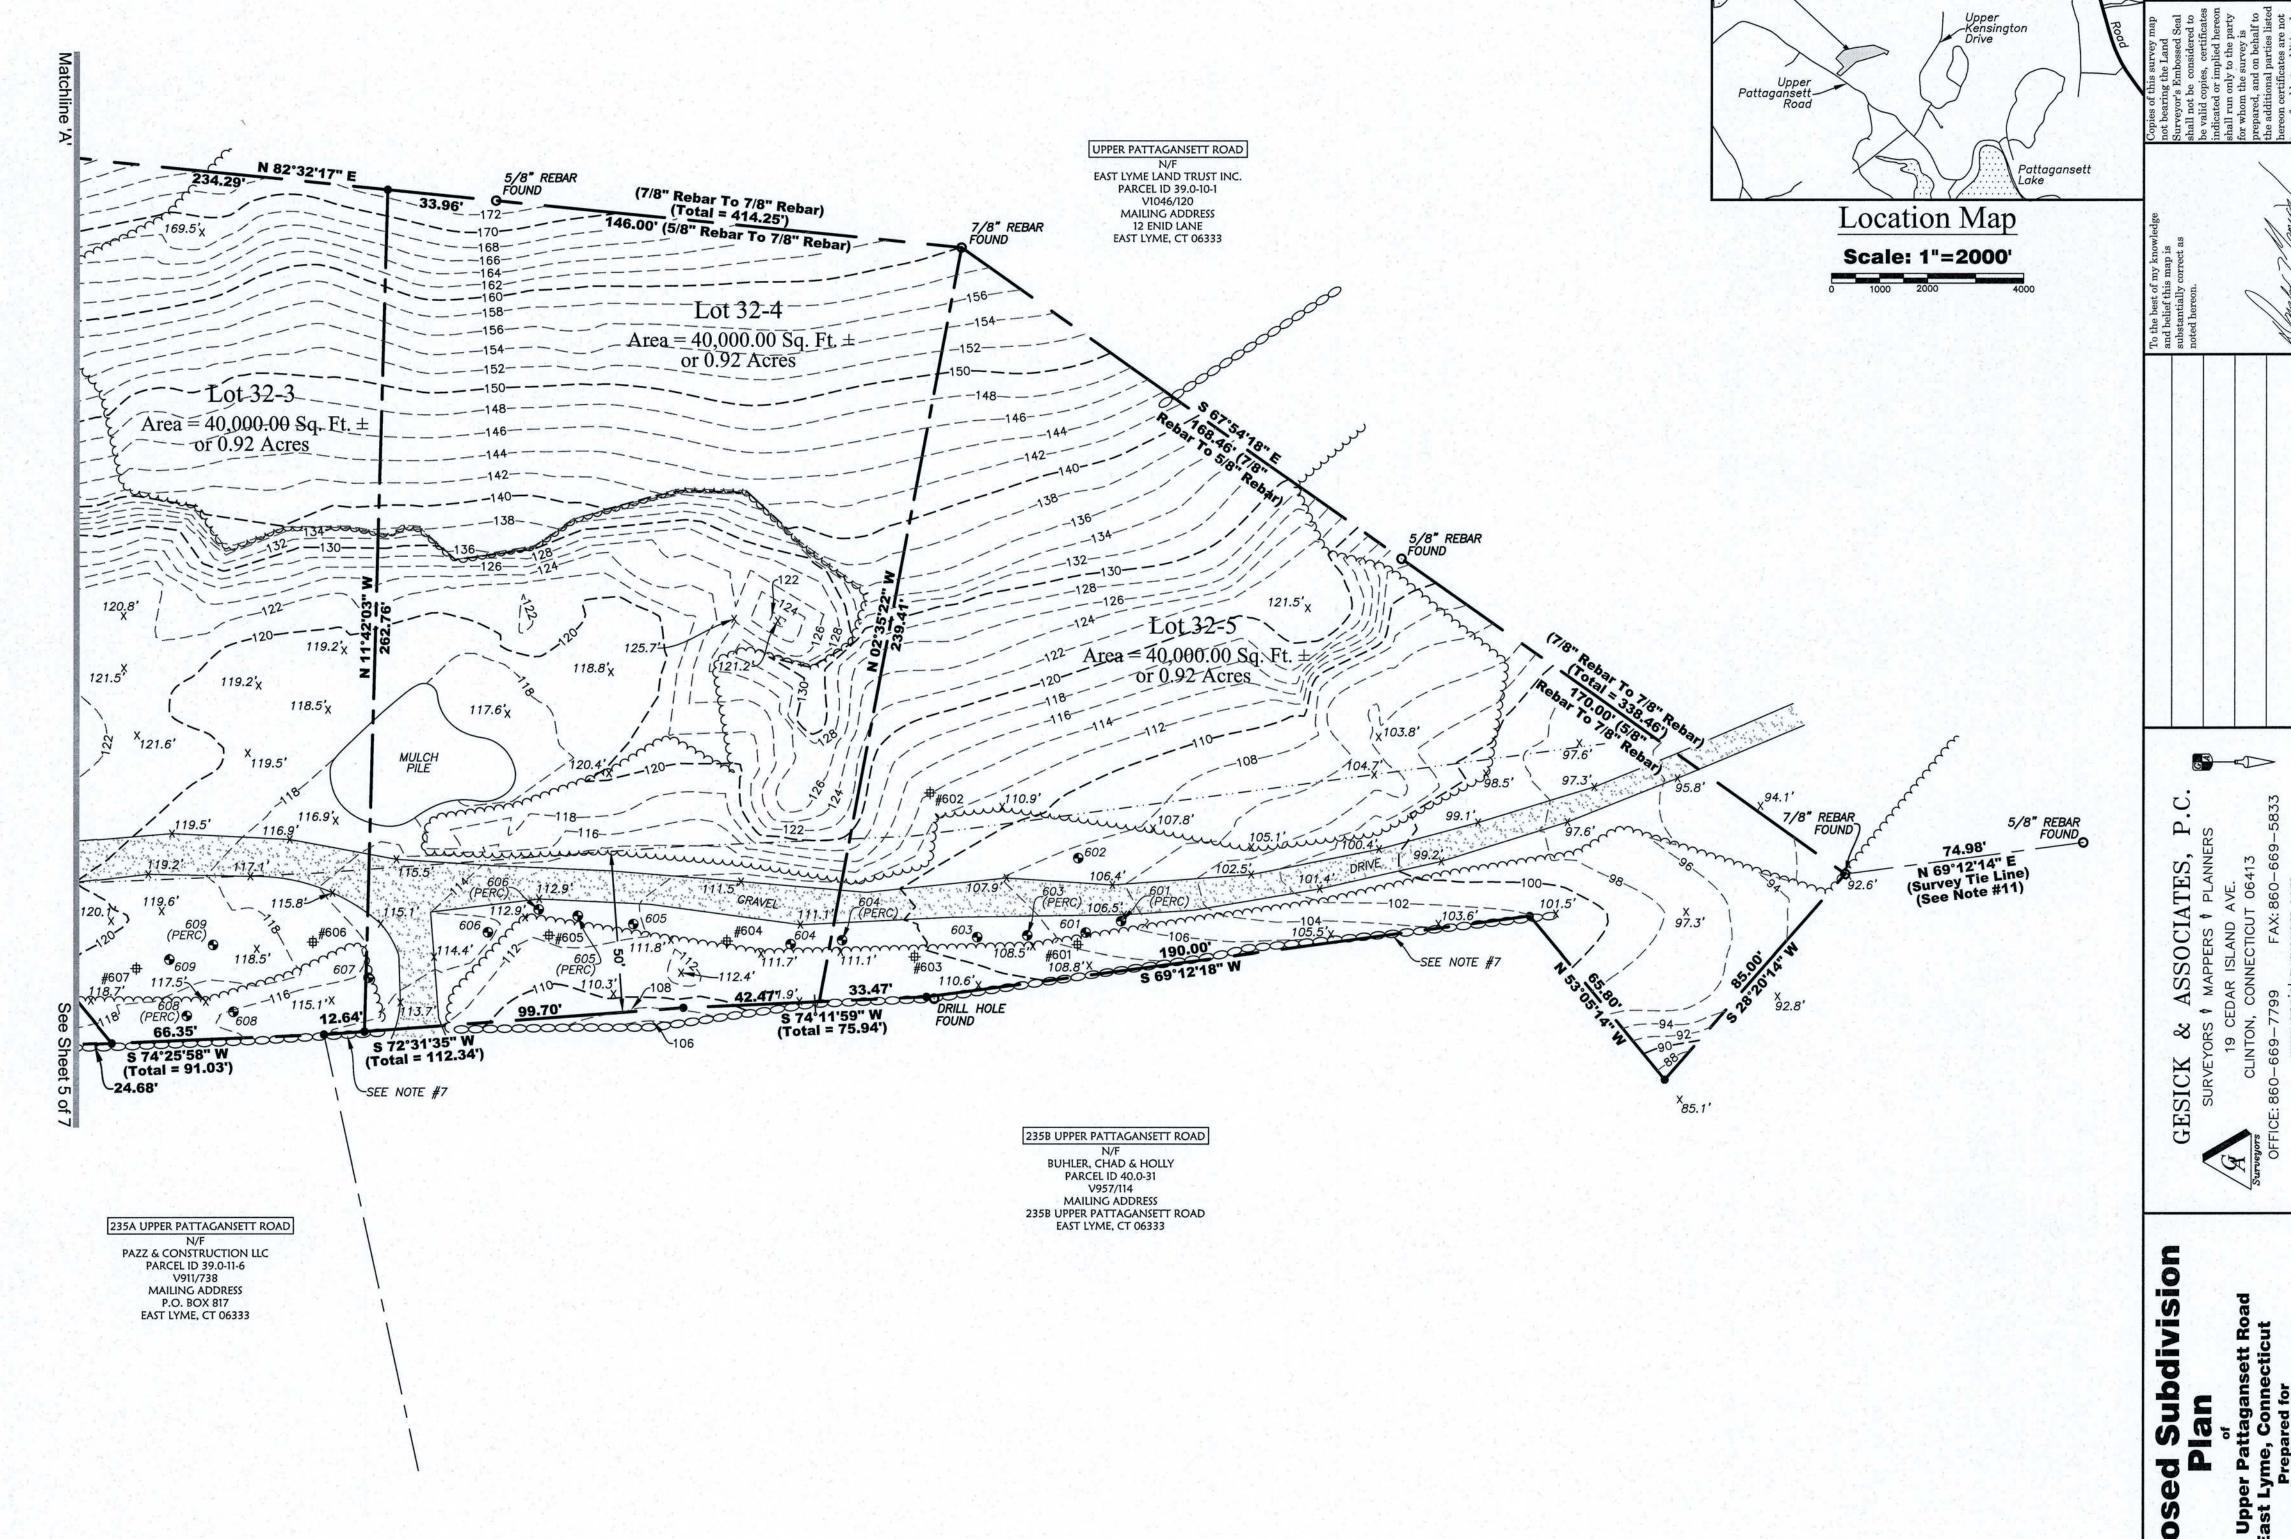
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237 Upper Pattagansett Road East Lyme, Connecticut

Subject Parcel Information

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VOLUME 1094 PAGE 646 LAND USE ZONE: R40

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Reference Maps

PROPERTY SURVEY OF 237 UPPER PATTAGANSETT ROAD EAST LYME, CONNECTICUT PREPARED FOR ENGLISH HARBOUR ASSET MANAGEMENT LLC" PREPARED BY GESICK & ASSOCIATES P.C. DATED MARCH 3, 2023 SCALE 1"=50"

Subdivision lan 20 90

> Revisions 8/12/2025 - Revised Per Comments 9/3/2025 - Revised Per Comments

(3C)

Date: January 17th, 2025 Drawing: 23-005h

Drawn: P.H.

Scale: 1"=30'

5 of 7

EROSION & SEDIMENT CONTROL NARRATIVE

- DISTURBANCE OF SOIL SURFACES IS REGULATED BY STATE LAW. ALL WORK SHALL COMPLY WITH AN APPROVED "EROSION AND SEDIMENT CONTROL PLAN" TO PREVENT OR MINIMIZE SOIL EROSION.
- 2. THE INSTALLATION AND MAINTENANCE OF EROSION CONTROL DEVICES IS THE RESPONSIBILITY OF THE LAND OWNER, DEVELOPER, AND THE EXCAVATION CONTRACTOR. TOWN OFFICIALS SHALL BE NOTIFIED IN WRITING OF THE NAME, ADDRESS AND TELEPHONE NUMBER OF THE INDIVIDUAL RESPONSIBLE FOR THIS WORK.
 - THE CONTRACTOR SHALL USE THE "CONNECTICUT GUIDELINES FOR SOIL EROSION AND SEDIMENT CONTROL" (2002), AS AMENDED, AS A GUIDE IN CONSTRUCTING THE EROSION AND SEDIMENT CONTROLS INDICATED ON THESE PLANS. THE GUIDELINES MAY BE OBTAINED FROM THE CONNECTICUT COUNCIL ON SOIL AND WATER CONSERVATION, STATE OFFICE BUILDING, HARTFORD, CT.06106.
- THE CONTRACTOR SHALL INFORM ALL CONSTRUCTION SITE WORKERS ABOUT THE MAJOR PROVISIONS OF THE EROSION AND SEDIMENT CONTROL PLAN AND SEEK THEIR COOPERATION IN AVOIDING THE DISTURBANCE OF THESE CONTROL MEASURES.
- 5. THE CONTRACTOR SHALL SCHEDULE ALL OPERATIONS TO LIMIT DISTURBANCE TO THE SMALLEST PRACTICAL AREA FOR THE SHORTEST POSSIBLE TIME.
- . THE CONTRACTOR IS RESPONSIBLE FOR THE TIMELY INSTALLATION, INSPECTION, REPAIR OR REPLACEMENT OF EROSION CONTROL DEVICES TO INSURE PROPER OPERATION.
- 7. THE CONTRACTOR SHALL INSPECT AND REPAIR EROSION AND SEDIMENT CONTROL DEVICES AT THE END OF EACH WORKING DAY AND AFTER EACH STORM.
- 8. THE CONTRACTOR SHALL NOTIFY THE ENGINEER OF UNSATISFACTORY EROSION CONDITIONS NOT CONTROLLED BY THE EROSION AND SEDIMENT CONTROL PLAN AND SHALL INSTALL ADDITIONAL MEASURES AS DIRECTED.
- 9. FIELD CHANGES TO THE EROSION AND SEDIMENT CONTROL PLAN
 SHALL BE MADE ONLY WITH THE APPROVAL OF THE ENVIRONMENTAL
 TOWN PLANNER OR AGENT. i.e. LOCATION OF SILT FENCE, STOCKPILE, DE—
 WATERING AREA etc.
- 10. ACCUMULATED SEDIMENT REMOVED FROM EROSION CONTROL DEVICES IS TO BE SPREAD AND STABILIZED IN LEVEL, EROSION RESISTANT LOCATIONS AS GENERAL FILL WITHIN LAWN AND LANDSCAPE AREAS.
- 11. ALL DISTURBED AREAS NOT COVERED BY BUILDINGS, PAVEMENT OR WOOD MULCH SHALL BE PLANTED WITH GRASS ON 4 IN. TOPSOIL OR 8" SAND.
- 12. MULCHING: IMMEDIATELY FOLLOWING SEEDING, MULCH THE SEEDED SURFACE WITH STRAW OR HAY AT A RATE OF 70 LBS./1000 SF. SPREAD MULCH BY HAND OR MULCH BLOWER. PUNCH MULCH INTO SOIL SURFACE WITH TRACK MACHINE APPROXIMATELY 2-3 IN. TO ANCHOR.
- SEEDING: BETWEEN APRIL 1 TO JUNE 1, AND AUGUST 15 TO SEPTEMBER 1. ALL DISTURBED AREAS SHALL BE IMMEDIATELY GRADED AND SEEDED TO PROMOTE STABILIZATION OF SLOPES. SEEDING SHALL BE DONE IN ACCORDANCE WITH THE ARCHITECTS SEEDING AND SLOPE STABILIZATION DIRECTIVES.
- 14. A FABRIC FILTER SOCK SHALL BE USED FOR ANY DEWATERING.
- 15. STRAW EROSION BLANKETS WILL BE USED ON ALL DISTURBED SLOPES OF 25% OR GREATER IN ADDITION TO STANDARD EROSION CONTROL MEASURES.

GENERAL CONSTRUCTION SEQUENCE - COMMON DRIVEWAY

- SECURE ALL NECESSARY PERMITS. NOTIFY "CALL BEFORE YOU DIG" (1-800-922-4455) AT LEAST 72 HOURS PRIOR TO EXCAVATION. SCHEDULE AND ATTEND A PRE-CONSTRUCTION CONFERENCE WITH TOWN STAFF.
- CLEARING LIMITS WILL BE FLAGGED BY ENGINEER PRIOR TO WORK BEING DONE. LIMIT OF WORK ADJACENT TO WETLANDS WILL NOT BE EXCEEDED.
- 3. REMOVE TREES, BRANCHES AND BRUSH WITHIN AREAS TO BE CLEARED, CHIP BRANCHES AND BRUSH FOR USE AS MULCH.
- INSTALL CONSTRUCTION EXIT (ANTI-TRACKING PAD) AND INSTALL SEDIMENT BARRIERS ALONG THE LIMITS OF GRADING AND AT THE LIMITS OF CLEARING FOR TREE PROTECTION.
- 5 CHECK AND REPAIR E&S CONTROLS AS NECESSARY.
- 6. GRUB STUMPS AND REMOVE BRUSH
- STRIP AND STOCKPILE TOPSOIL ONLY IN AREAS TO BE FILLED OR GRADED AND STOCKPILE ON SITE IN AN AREA
 NOT IN WAY OF CONSTRUCTION, SEED AND MULCH STOCKPILE OR COVER WITH NETTING. PLACE AND STAKE
 HAY BALES AROUND STOCKPILES.
- 8. ROUGH GRADE COMMON DRIVEWAY.
- 9. PLACE GRAVEL AND PAVEMENT IN COMMON DRIVEWAY.
- 10. RE-SPREAD TOPSOIL ON SHOULDERS AND DISTURBED AREAS.
- 11. GRADE, LIME, FERTILIZE AND SEED REMAINING LAWN AREAS WITH FORMAL GRASS SEED MIXTURE BY JUNE 1 OR OCTOBER 1 DEPENDING ON ACTUAL CONSTRUCTION SCHEDULE.
- 12. REMOVE EROSION CONTROL DEVICES UPON AUTHORIZATION OF TOWN OFFICIALS.

SOIL AND EROSION CONTROL

- 1. HAY BALES / SILT FENCE ARE TO BE INSTALLED PRIOR TO CONSTRUCTION.
- 2. ONLY REMOVE TREES AND VEGETATION NECESSARY FOR CONSTRUCTION.
- 3. PERMANENT SEEDING SHOULD BE DONE AS SOON AS POSSIBLE AFTER CONSTRUCTION FINISHES. LIME AND FERTILIZE. RECOMMENDED SEEDING DATES ARE APRIL 15 TO JUNE & AUG. 15 TO OCT. 1.
- 4. HAY BALES AND SILT FENCE TO REMAIN WHERE PLACED UNTIL ALL DISTURBED AREAS ARE PERMANENTLY STABILIZED.
- 5. NO ERODED SEDIMENT SHALL BE PERMITTED TO LEAVE THE SITE OR WASH INTO THE DRAINAGE SYSTEM.
- 6. IF SEEDING CANNOT MEET RECOMMENDED DATES, TEMPORARY MULCH IS TO BE APPLIED IN ACCORDANCE WITH THE TABLE BELOW.

MULCHES

RATES
PER 1000 FT


STRAW OR HAY 1/2 - 2 TONS
PER ACRE

RATES
PER 1000 FT

NOTES


FREE FROM WEEDS & COURSE
MATTER. MUST BE ANCHORED
SPREAD WITH MULCH BLOWER
OR BY HAND

- 8. ANY HAY BALES OR SILT FENCE REMOVED DURING CONSTRUCTION SHOULD BE REPLACED EACH NIGHT.
- 9. ANY MATERIAL STOCK PILED SHOULD BE TEMPORARILY SEEDED.

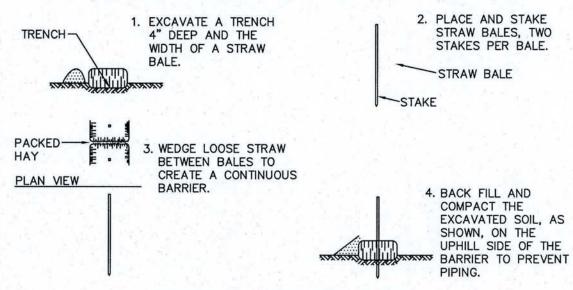

TYPICAL HAY BALE INSTALLATION

- 10. ALL ROAD SECTION EMBANKMENTS, EITHER CUT OR FILL, SHOULD BE STABILIZED AT THE TOE OF THE SLOPE BY STAKED HAY BALES OR SILT FENCE.
- 11. SWALES AND DIVERSION STRUCTURES SHOULD HAVE HAY BALES PLACED ACROSS THEM EVERY 100' IN ACCORDANCE WITH THE DETAIL BELOW.

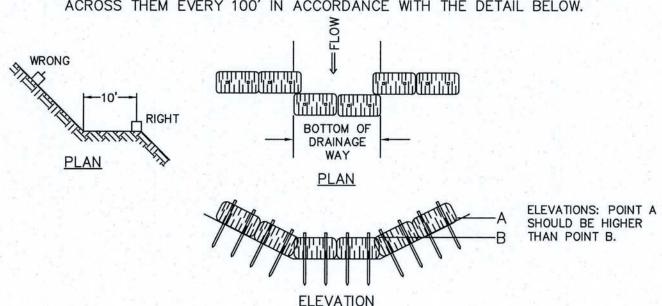

Nottingham Hills Subdivision
East Lyme, Connecticut

To the best of my knowledge this may be walted only the street of my knowledge the more of the street of my knowledge the consultated of implicated or implications are not on shorth to the street as a part of the difficult process of the difficult process of the difficulty of the street of the street



GESICK & ASSOCIATES, I SURVEYORS & MAPPERS & PLANNERS 19 CEDAR ISLAND AVE.

CLINTON, CONNECTICUT 06413
FFICE: 860-669-7799 FAX: 860-669-

₹

Nottingham Hills Subdivision

6 Lot Re-Subdivision of Lot 32

Revisions
8/12/2025 - Revised Per
Comments
9/3/2025 - Revised Per
Comments

Date: January 17th, 2025
Drawing: 23-005h

Drawn: P.H.

6 of 7

Paul Geraghty

From: Danielle Holmes <dholmes@llhd.org>
Sent: Tuesday, January 7, 2025 12:21 PM

To: Paul Geraghty
Subject: Re: Test Pits

Please let me know the appropriate name and address so we can cut a check and get that \$600 refunded for you.

For Holmes Rd, I'd like someone on site when I go back. Should I reach out to Tim for coordinating that, or maybe JP?

Here is the data for 237 Upper Patt:

TP611 depth 96"
0-13" Fill
13-20" Buried TS
20-38" Orange brown fine sandy loam
38-96" Gray brown sandy till w/rocks
No GW
Mottled @ 36"
Roots to 56"
No refusal

TP612 depth 76" - refusal?
0-3" Leaf litter & TS
3-18" Orange brown silty sand
18-76" Yellow to gray brown compact sandy till w/rocks
No GW
No apparent redox
Roots to 59"
Refusal @ 76"

TP613 depth 70" - refusal
0-4" Leaf litter & TS
4-24" Yellow brown sandy loam
24-70" Compact yellow brown sandy till w/rocks
No GW
No apparent redox
Roots to 40"
Refusal at 70"

TP610 depth 77" - refusal?
0-14" Fill
14-23" Buried TS
23-41" Yellow brown medium silty sand

41-77" Compact gray sandy till, trace gravel

Mottled @ 35" Roots to 49" Refusal at 77"

TP609 depth 86" - refusal?
0-14" Fill
14-20" Buried TS
20-45" Yellow brown very fine silty sand, damp
45-86" Compact sandy till, trace cobbles
No GW
Roots to 53"
Mottled @ 42"

TP601 (open) depth 38"

Refusal?

TP603 (open) depth 40"

TP604 depth 72" - refusal
0-14" Fill
14-18" Buried TS
18-45" Orange brown fine sandy loam
45-72" Compact sandy till w/rocks
Roots to 50"
No GW


redox? Refusal @ 72"

NOTE: Hole was tough to read. Side walls were frozen. Confirmation testing may be needed.

TP605 depth 82" - refusal? 0-20" Mixed TS & fill 20-82" Huge boulder

NOTE: Same comment as above - other wall of TP was not accessible, no ramp, and frozen from previous excavation.

TP606 depth 79" - refusal?
0-13" Fill
13-19" Buried TS
19-57" Yellow brown fine sandy loam, rocky
57-79" Compact sandy till
Mottled @ 54"
Roots to 60"
No GW
Refusal @ 79"
NOTE: Hole disturbed. Natural profile hard to ID (previous TP?)

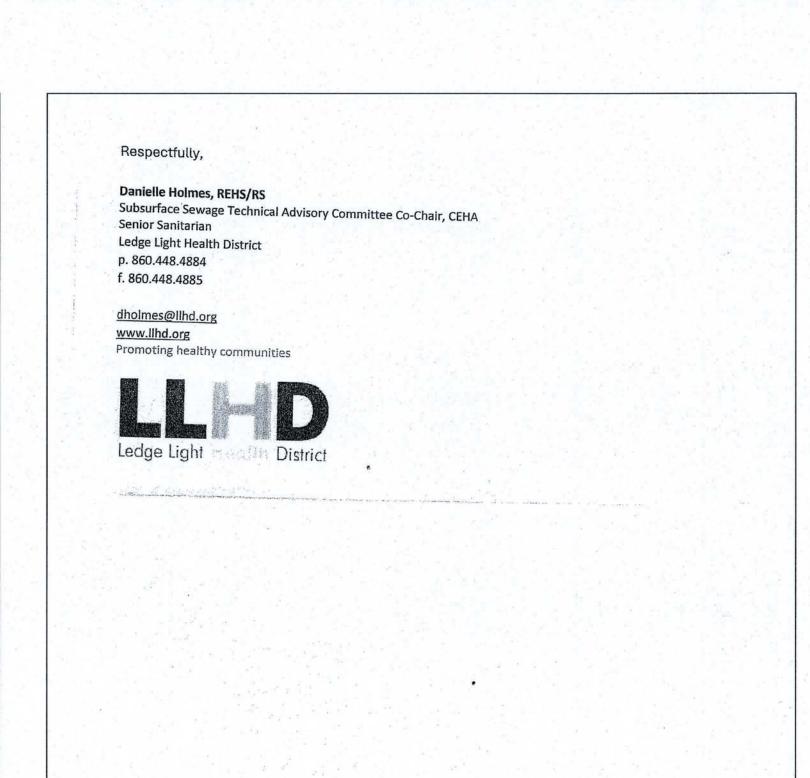

Nottingham Hills Subdivision

East Lyme, Connecticut

Powers
Loke

Description

Des

Ledge Light Health District

Promoting healthy communities

Property Addresss: 237 Upper Pattagansett Rd Town: East Lyme

DEEP TEST PIT DATA/SOIL DESCRIPTIONS

DATE: 12-14-2023 TEST PIT: 601	TEST PIT: 602	rd all Test Pits) TEST PIT: 603	TEST PIT: 604
0-3" Topsoil -13" Lt. Br. Fine sandy loam, some gravel -64" Br. Fine sand w/gravel	0-20" Fill or disturbed material, some decomposed rock	0-3" Topsoil -9" Lt. Br fine sandy loam -61" Lt. yellow br fine sand w/gravel, few cobbles	0-12" Fill -18" Buried topsoil -69" Br f-v.fine sandy loam w/gravel, some cobbles * water seeping at west end of hole – likely surface water
Mottles: none observed	Mottles: none	Mottles: possible at 42"	Mottles: none observed
GW: none	GW: none	GW: none	GW: none?
Ledge: 64"	ge: 64" Ledge: 20"		Ledge: 69"
Roots:	Roots: to	Roots to:	Roots to:
Restrictive: 64"	Restrictive: unsuitable	Restrictive: 61"	Restrictive: 69"

TEST PIT: 605	TEST PIT: 606	TEST PIT: 607	TEST PIT: 608	
0-20" Fill/disturbed soil -30" Buried topsoil -62" Br. F-v.fine sandy loam, some gravel, some cobbles	0-7" Fill -17" Buried topsoil -67" Br f-v.fine sandy loam, w/gravel	0-10" Topsoil -43" Lt. Br fine sandy loam – likely fill, lg. boulder at 12"	0-9" Topsoil -54" Br f-v.fine sandy loam w/some gravel -66" Lt. br f-med sand w/gravel few cobbles	
Mottles: none observed Mottles: none observed		Mottles: none observed	Mottles: none observed	
GW: 20" (possibly surface water)	GW: seep 16", standing 58" (possibly surface water)	GW: none	GW: none	
Ledge: 62"?	Ledge: 67"?	Ledge: 43"?	Ledge: 66"	
Roots:	Roots: to	Roots to:	Roots to:	
Restrictive:	Restrictive:	Restrictive: 43"	Restrictive: 66"	

GROUNDWATER TABLE (Near max., below max., etc.): below max
SOIL MOISTURE (High, medium, low, etc.): high

SITE TESTING NOTTINGHAM HILLS SUB., PHASE III SEPTEMBER 19, 2005

TEST HOLE #501

TEST HOLE #500
0 - 8/10" -topsoil & humus
8 - 32/44" -brown fine loamy sand/sandy loam
32 - 67/91" -orange/tan medium/fine to fine silty sand & stone (76"/91"/67" N-S)
67 - 95/122" -dark orange/brown med/fine to fine silty sand & stone
(bottom 101"/122"/95" - N-S), heavily cemented due to iron pcpt.

top 1 ft. of layer
-ledge 101-122-95" N-S, decomposed stone mix north end at 76", no water,
max. water 76"/91"/67" N-S

0 - 8/10" -topsoil & humus 8 - 32" -brown sandy loan 32 - 84/87" -gray/tan med/fine to fine silty sand & stone 84 - 86/96" -dark brown fine silty sand & stone -ledge ? 86-96", no water, max. water 84/87" TEST HOLE #502

0 - 32" -topsoil, humus and orange/brown loamy sand/sandy loam 32 - 86" -tan to gray/tan med/fine to fine silty sand & stone 86 - 110" -dark brown fine silty sand & stone -no ledge ?, no water, max. water 86"+/-

	*					ATION FOR A SU		- 2		
Location:	Upper Pa	atagansett Rd (3	9-10-2), Ea	ast Lyme, CT (Ne	w Engl	and National)		Weather: 25	5F	
Percent S	lope: 10-1	5%	Pare	nt Material:		-	Til	Date:		4 Time: 10:15am
Complete	d by: Rya	n McCammon			Accur	acy Assured by (if P	.E. complet	ed form):	Robert Pfani	
		P.E. or Certified Loc	al Health Ag	ent :					Cert	fied Local Health Agent
Others Pr	esent for S	lite Investigation	Jason Pa	azzaglia · ·	· · · · ·					
	1 00"					Developer, P.E., etc.)	m 1 1 1 1 1 1 1 1 1 1 1 1 1 1 1 1 1 1 1	Min		nie za koa
Test Pit #		Depth to Obser Matrix Color	ved Groun	d-Water (inches) oximorphic Featu	: Weep	Soil Texture	Standing:	Soil	Observed	d Ledge N/O
Horizon	Depth (inches)	(moist)	Depth	Color	%	(USDA)	Gravel	Consistence	Roots	Other
A	0-12"	Dark Brown	Dopur		1 70	topsoil		friable	Yes	
B1		Orange Brown	1		1	fine sandy loam		friable	No	
C1	-	Tan/Grey	43"	Orange	15	fine silty loam		firm	No	
C2	69-98"	Grey	1	l congo	1	med loamy sand	-	loose	No .	rock
Test Pit #			Jad Cratin	d Mater Unabas	J. Wash	ing:N/O		A	***************************************	Ledge N/O
Soil	Depth	Matrix Color	Red	oximorphic Featu	res	Soil Texture	Gravel	Soil		
Horizon	(inches)	(moist)	Depth	Color	1 %	(USDA)		Consistence	Roots	Other
A	0-8"	Dark Brown				topsoil .		friable	Yes	
B1	8-22"	Orange Brown	1			fine sandy loam	10	friable	No	Boulders
B2	22-45"	Tan :		_88 = 20 = 20		med loamy sand	15	very friable	No	Boulders
C1	45-84"	Grey .				med loamy sand	. 20	loose	No 5.	rock
Test Pit#	3-92"	Depth to Observ	ved Groun	d-Water (inches):	Weepi	ing: N/O	Standing:	N/O	Observed	Ledge 48"N-92"S
Soil	Depth	Matrix Color		oximorphic Featu	res	Soil Texture	Gravel	Soil	Roots	Other
Horizon	(inches)	. (moist)	Depth	Color	%	(USDA)		Consistence		Other
Α	0-4"	Dark Brown				topsoil	5	friable	Yes	
B1 .	4-27"	Orange Brown	1			fine sandy loam .		friable	No	Boulders
B2	27-48"	Tan 1			<u> </u>	med loamy sand		very friable	No	ledge 48"-4' from N
C1	The same of the sa	Tan/Grey				med loamy sand	20	very friable	No	ledge 90" 8' & 92" 15'
Test Pit #:				d-Water (inches):			Standing:		Observed	Ledge N/O
Soil	Depth	Matrix Color		ximorphic Featu	-	Soil Texture	Gravel		Roots	Other
	(inches)	(moist)	Depth	Color	%.	(USDA)	-	Consistence		94161
4	0-6"	Dark Brown		- 1	· ·	topsoil	-	friable .	Yes	
B1	6-23"	Orange Brown				fine sandy loam	-		No .	Boulders .
B2	23-72"	Tah				med loamy sand	-		No .	Boulders
C1 -	72-90"	Grey		*		med sandy loam	10	friable	No ·	Boulders

Betails

Nottingham Hills Subdivision
6 Lot Re-Subdivision of Lot 32

Revisions
8/12/2025 - Revised Per Comments
9/3/2025 - Revised Per Comments

Date: January 17th, 2025

Drawing: 23-005h

Drawn: P.H.


7 of 7


ASSOCIATES,


WAPPERS & PLANNER
CEDAR ISLAND AVE.


W, CONNECTICUT 06413


7799 FAX: 860-669-

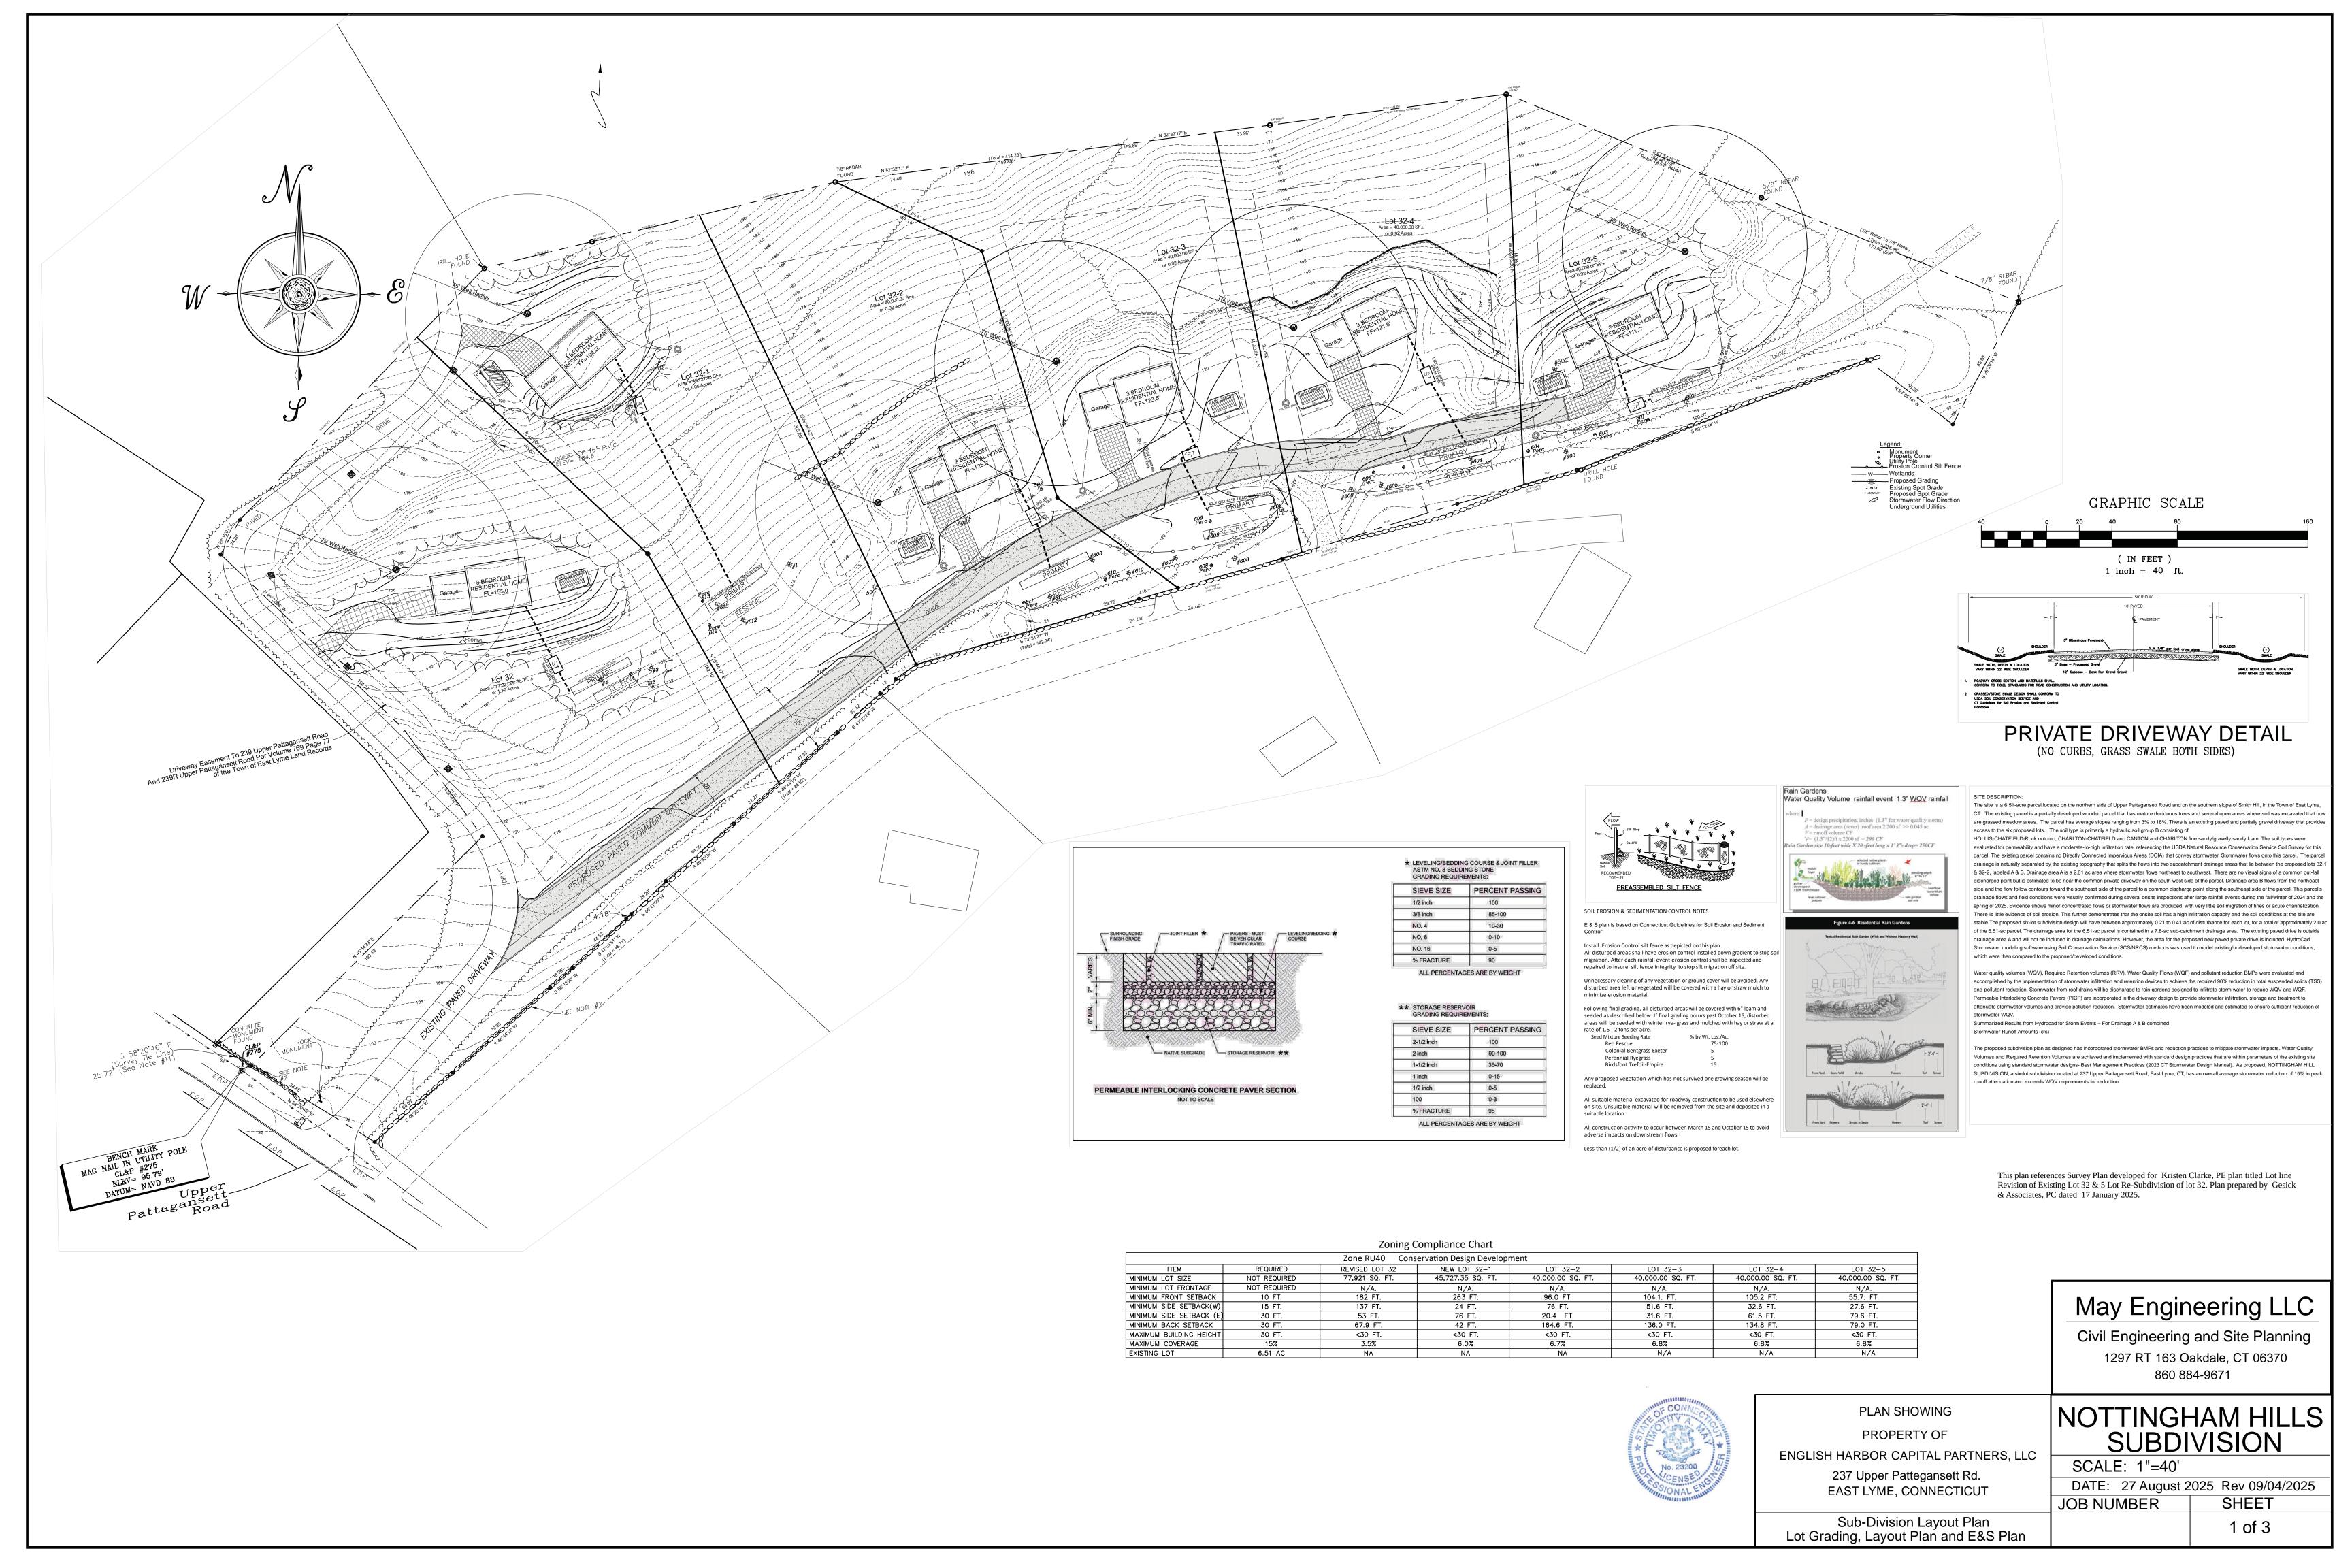

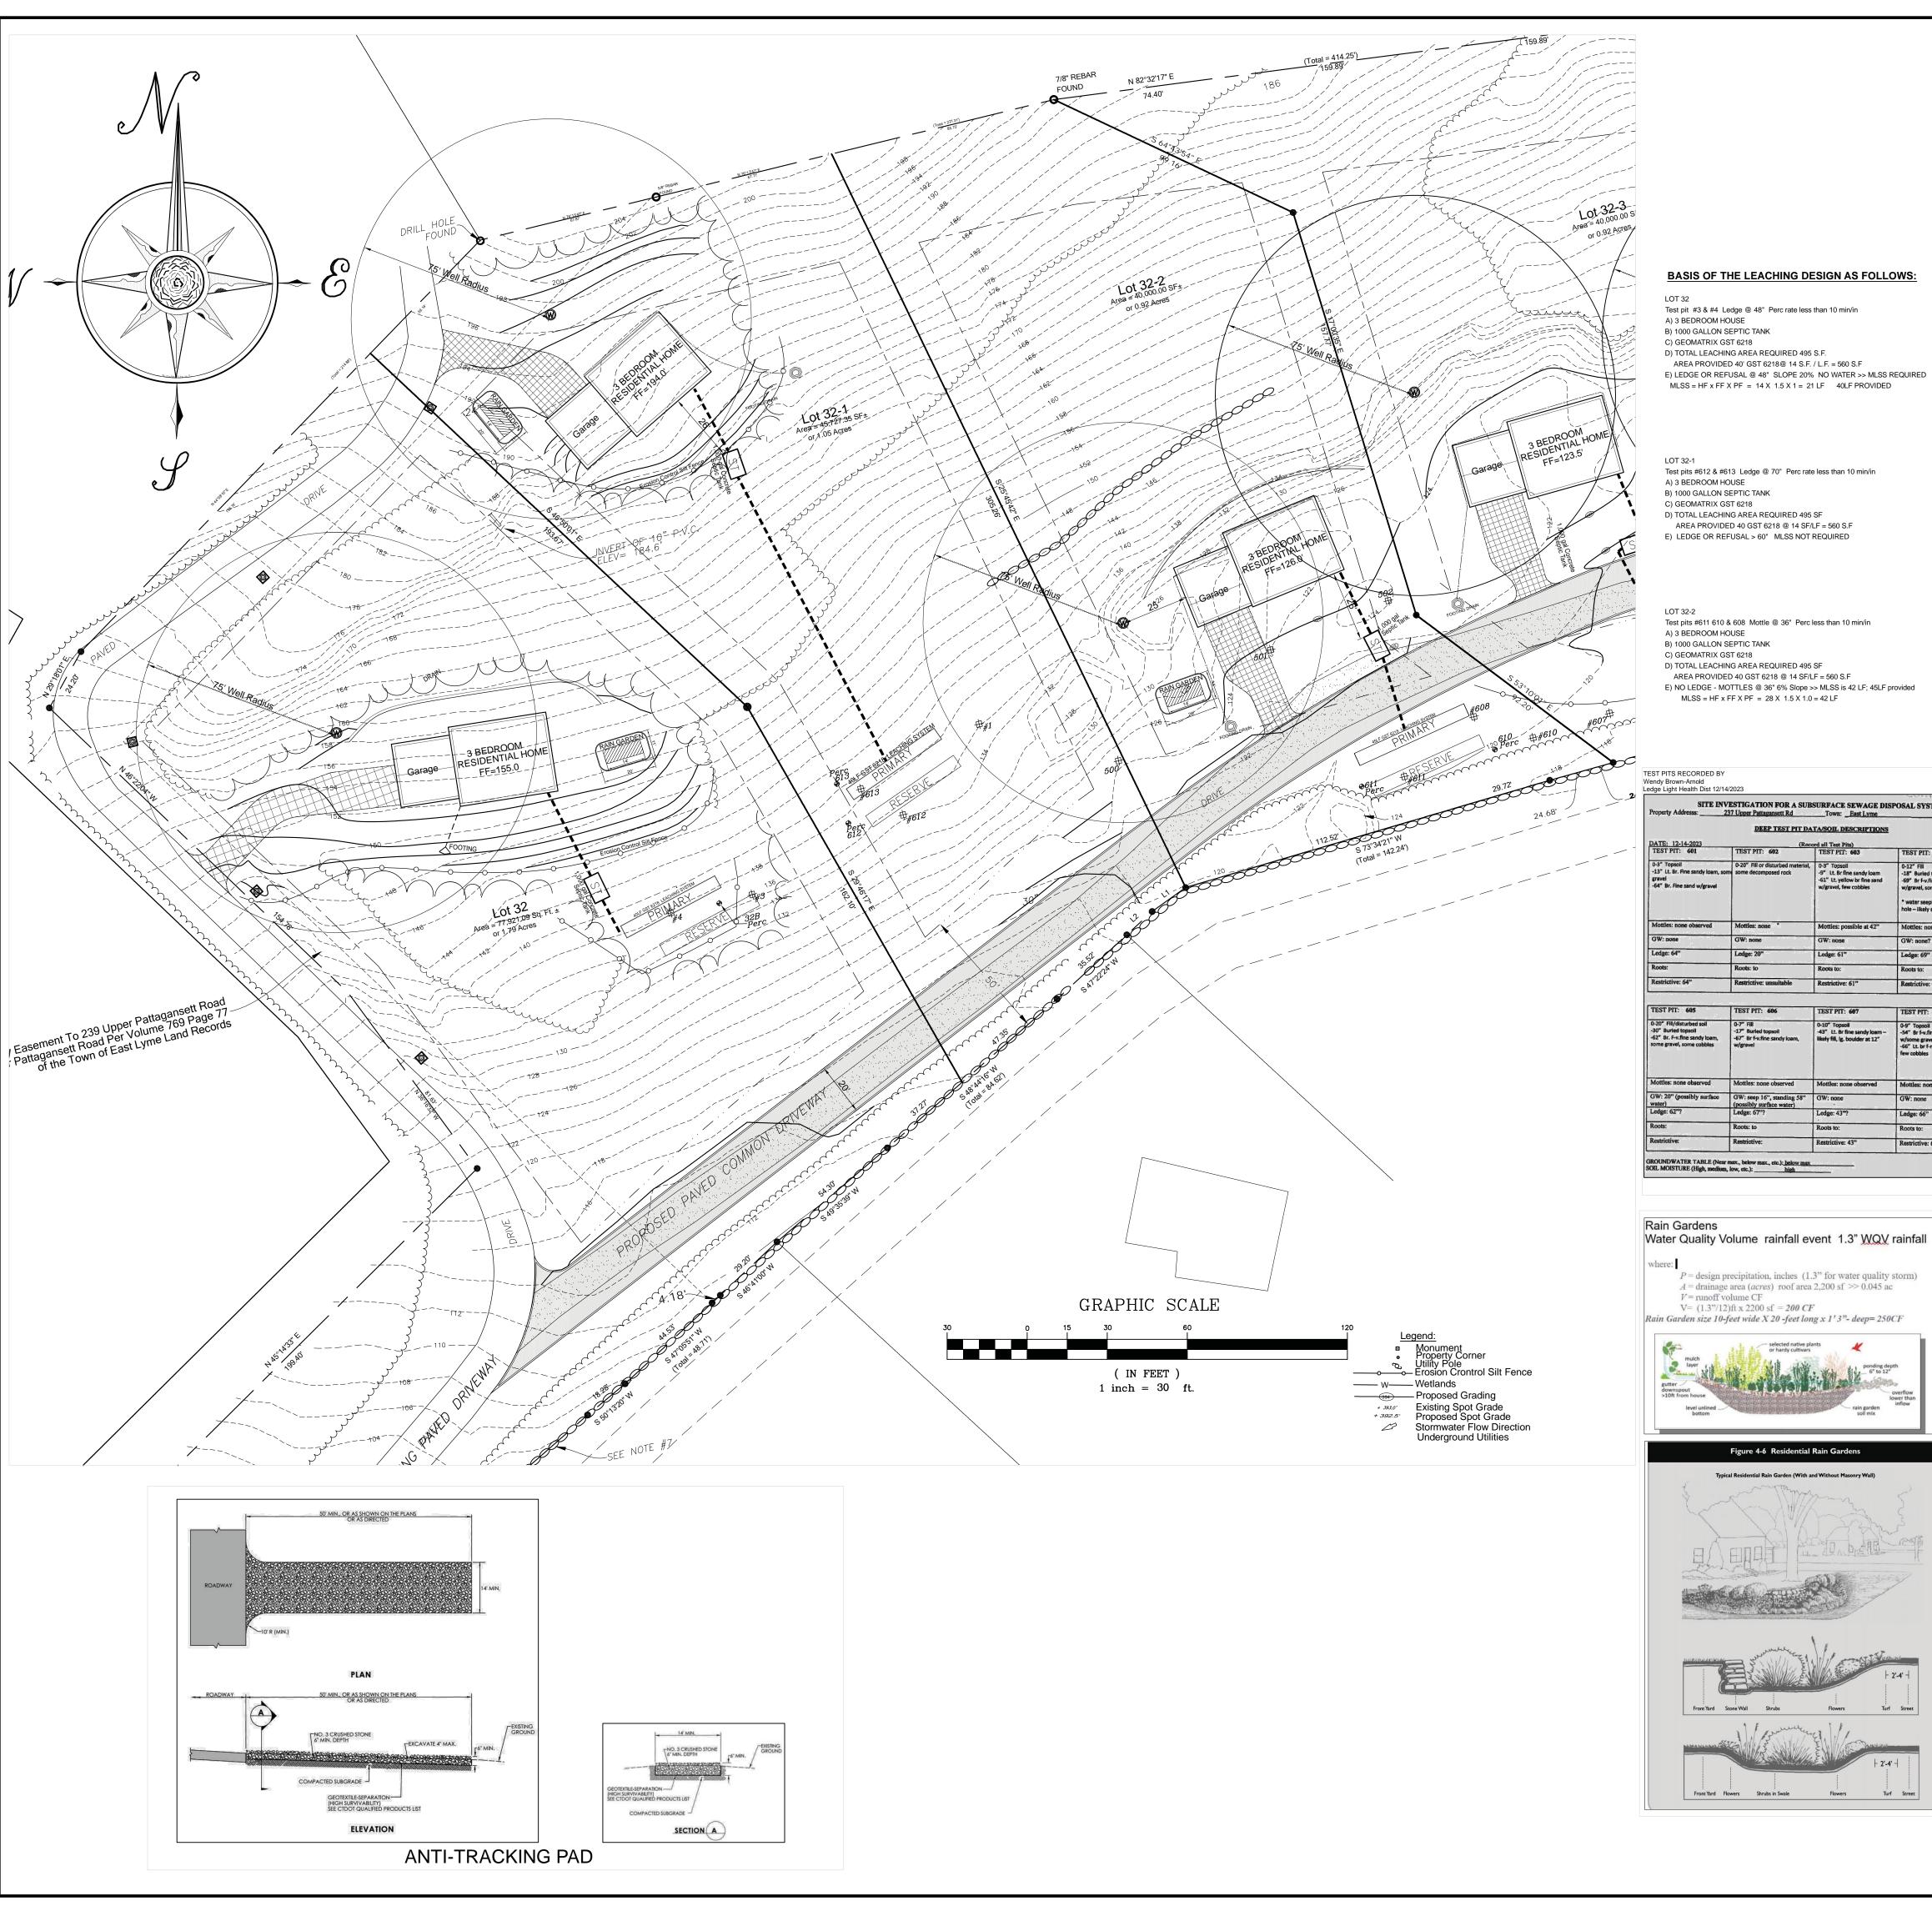


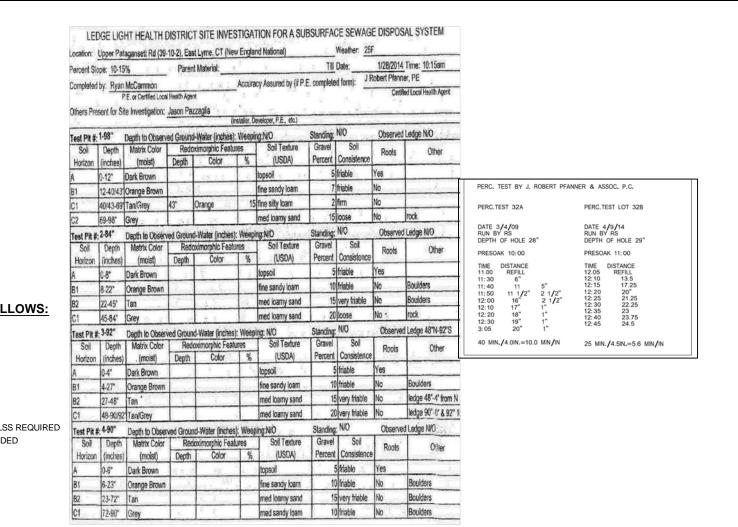

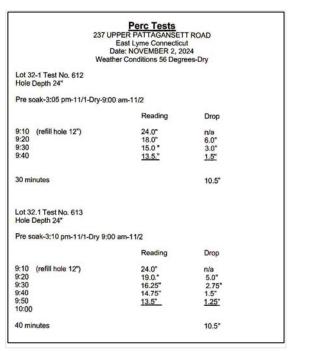

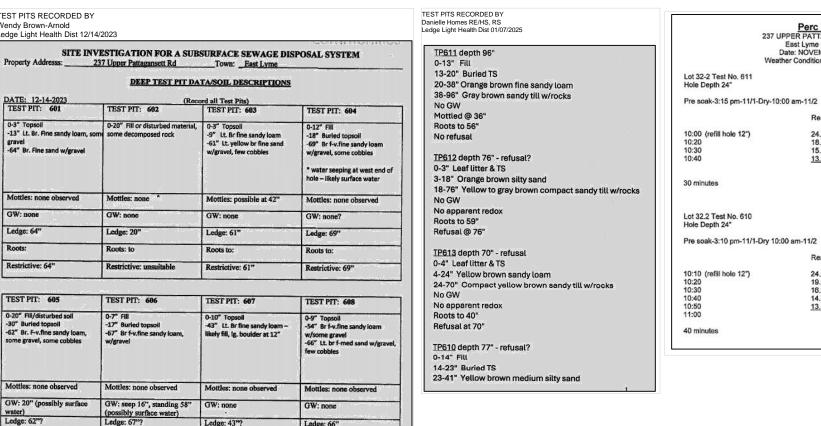

RECOMMENDED TOE-IN

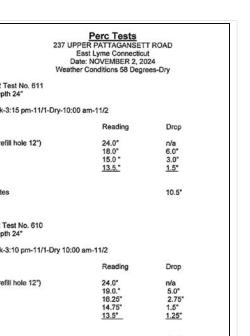

1,000 GALLON TWO COMPARTMENT SEPTIC TANK REQUIRED BY CODE AND PROVIDED. EFFECTIVE LEACHING AREA REQUIRED PER CODE:. GST 6218 LEACHING SYSTEM DESIGN. 100% RESERVE AREA A BENCH MARK MUST BE SET IN THE AREA OF THE SYSTEM PRIOR AT THE TIME OF CONSTRUCTION. RESERVE AREA SHALL BE DESIGNED THE SAME AS THE PRIMARY A SITE PLAN REVIEW FOR APPROVAL IS REQUIRED FOR EACH PARCEL BEFORE PERMIT TO CONSTRUCT IS ISSUED.

PROPOSED THREE BEDROOM. NO TUBS GREATER THAN

LOT 32, 32-1, & 32-2 SANITARY DESIGN CRITERIA

100 GALLONS IN SIZE.

All disturbed areas shall have erosion control installed down gradient to stop soil migration. After each rainfall event erosion control shall be inspected and repaired to insure silt fence integrity to stop silt migration off site.

Unnecessary clearing of any vegetation or ground cover will be avoided. Any disturbed area left unvegetated will be covered with a hay or straw mulch to minimize erosion

E & S plan is based on Connecticut Guidelines for Soil Erosion and Sediment Control"

Following final grading, all disturbed areas will be covered with 6" loam and seeded as described below. If final grading occurs past October 15, disturbed areas will be seeded with winter rye- grass and mulched with hay or straw at a rate of 1.5 - 2 tons per acre. Seed Mixture Seeding Rate

Colonial Bentgrass-Exeter Perennial Ryegrass Birdsfoot Trefoil-Empire

SOIL EROSION & SEDIMENTATION CONTROL NOTES

Install Erosion Control silt fence as depicted on this plan

Any proposed vegetation which has not survived one growing season will be replaced.

All suitable material excavated for roadway construction to be used elsewhere on site. Unsuitable material will be removed from the site and deposited in a suitable location. All construction activity to occur between March 15 and October 15 to avoid adverse

Less than (1/2) of an acre of disturbance is proposed foreach lot.

impacts on downstream flows.

PERMEABLE INTERLOCKING CONCRETE PAVER SECTION
NOT TO SCALE

PREASSEMBLED SILT FENCE

May Engineering LLC

Civil Engineering and Site Planning 1297 RT 163 Oakdale, CT 06370

860 884-9671

PROPERTY OF ENGLISH HARBOR CAPITAL PARTNERS, LLC 237 Upper Pattegansett Rd. EAST LYME, CONNECTICUT

PLAN SHOWING


Lots #32, 32-1, 32-2


JOB NUMBER

Lot Grading, Layout Plan and E&S Plan

NOTTINGHAM HILLS SUBDIVISION SCALE: 1"=30' DATE: 27 August 2025 REV 09/04/25

SHEET 2 of 3

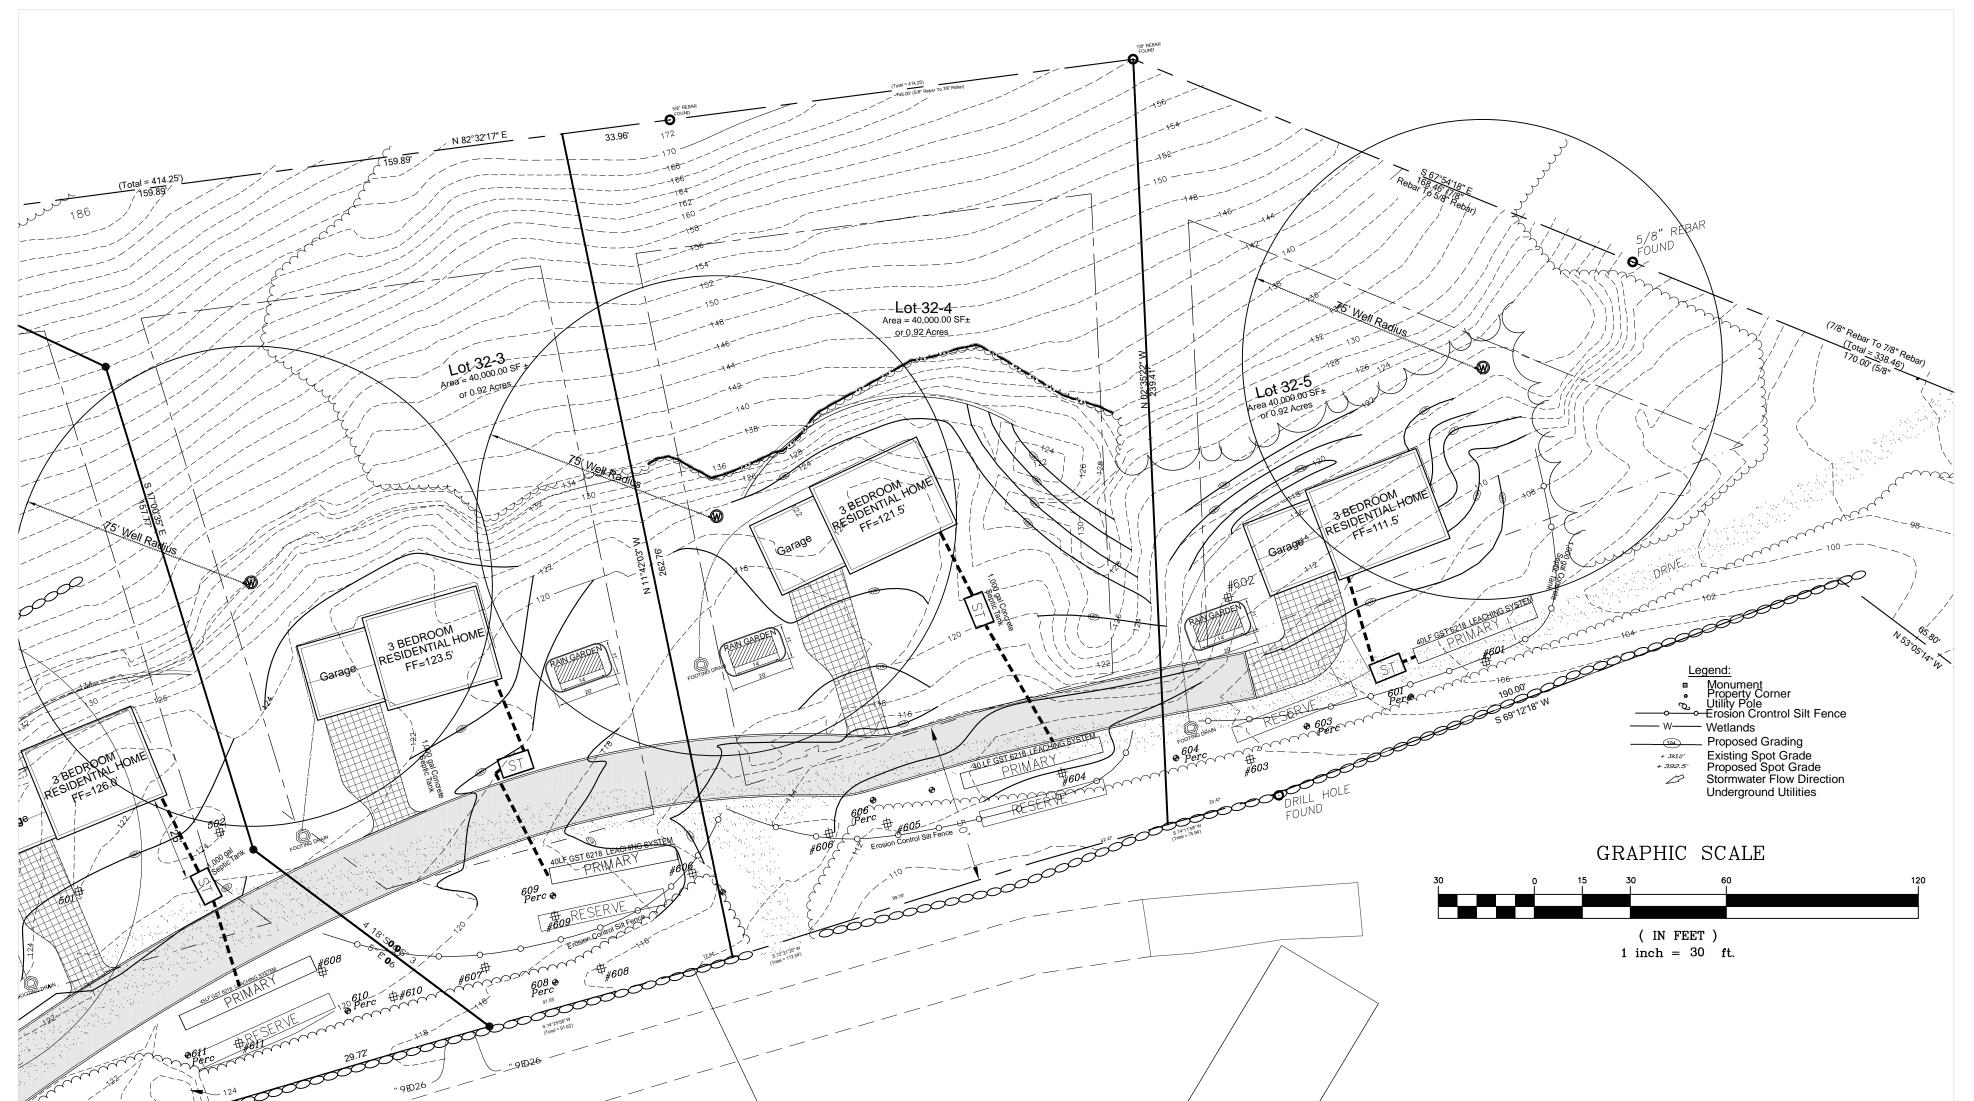

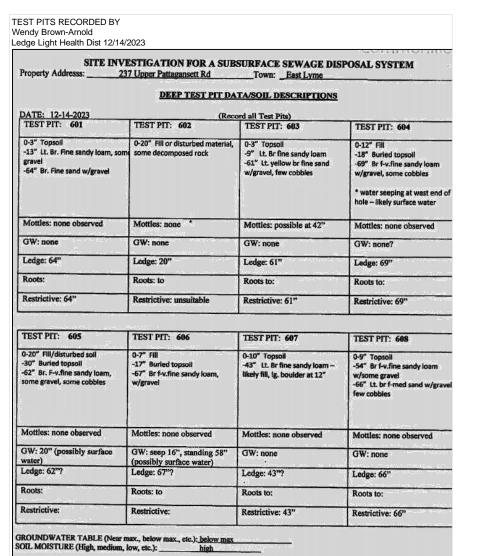

BASIS OF THE LEACHING DESIGN AS FOLLOWS:

Test pit #606 & 609 Mottles @ 42" Perc rate less than 10 min/in

A) 3 BEDROOM HOUSE B) 1000 GALLON SEPTIC TANK C) GEOMATRIX GST 6218

D) TOTAL LEACHING AREA REQUIRED 495 S.F. AREA PROVIDED 40' GST 6218@ 14 S.F. / L.F. = 560 S.F

E) RESTRICTIVE LESS THAN 60" SLOPE 5.5% MOTTLES >> MLSS IS REQUIRED MLSS = HF x FF X PF = 26 X 1.5 X 1.0 = 39 LF: 40LF PROVIDED

Test pits #604 Ledge @ 57" (69"-12") Perc rate less than 10 min/in

A) 3 BEDROOM HOUSE B) 1000 GALLON SEPTIC TANK

C) GEOMATRIX GST 6218

D) TOTAL LEACHING AREA REQUIRED 495 SF AREA PROVIDED 40LF GST 6218 @ 14 SF/LF = 630 SF E) LEDGE LESS THAN 60"; SLOPE 10% LEDGE at 57" >> MLSS 24 LF

MLSS = HF x FF X PF = 16 X 1.5 X 1.0 = 24 LF: 40LF PROVIDED

Test pits #601 Ledge @ 64" Perc rate less than 10 min/in A) 3 BEDROOM HOUSE

B) 1000 GALLON SEPTIC TANK C) GEOMATRIX GST 6218

D) TOTAL LEACHING AREA REQUIRED 495 SF AREA PROVIDED 40 GST 6218 @ 14 SF/LF = 560 S.F E) LEDGE LESS THAN 60" NO WATER >> MLSS NOT REQUIRED

LOT 32-3, 32-4, & 32-5

PROPOSED THREE BEDROOM. NO TUBS GREATER THAN

100 GALLONS IN SIZE.
1,000 GALLON TWO COMPARTMENT SEPTIC TANK REQUIRED BY CODE AND PROVIDED.

EFFECTIVE LEACHING AREA REQUIRED PER CODE:.
GST 6218 LEACHING SYSTEM DESIGN.100% RESERVE AREA

REQUIRED

A BENCH MARK MUST BE SET IN THE AREA OF THE SYSTEM PRIOR AT

THE TIME OF CONSTRUCTION.

RESERVE AREA SHALL BE THE SAME DESIGN AS THE PRIMARY
A SITE PLAN REVIEW FOR APPROVAL IS REQUIRED FOR EACH
PARCEL BEFORE PERMIT TO CONSTRUCT IS ISSUED.

Test pits Recorded By Danielle Holmes, REHS/RS Ledge Light Health District (EMAIL January 07 2025 from Daniel Holmes to Paul Geraghty)

0-14" Fill 14-18" Buried TS 18-45" Orange brown fine sandy loam 45-72" Compact sandy till w/rocks Roots to 50" No GW

Refusal @ 72" NOTE: Hole was tough to read. Side walls were frozen. Confirmation testing may be needed.

TP 605 depth 82" - refusal? NOTE: Same comment as above - other wall of TP was not accessible,

no ramp, and frozen from previous excavation.

TP606 depth 79" - refusal? 0-13" All 13-19" Buried TS 19-57" Yellow brown fine sandy loam, rocky 57-79" Compact sandy till Mottled @ 54" Roots to 60" NO GW Refusal@79"

NOTE: Hole disturbed. Natural profile hard to ID (previous TP?)

TP609 depth 86"- refusal? 0-14" Fill 14-20" Buried TS 20-45" Yellow brown very fine silty sand, damp 45-86" Compact sandy till, trace cobbles No GW Roots to 53" Mottled @ 42'

TP610 depth 77" - refusal? 14-23" Buried TS 23-41" Yellow brown medium silty sand

Refusal?

41-77" Compact gray sandy till, trace gravel Mottled @ 35" Roots to 49" Refusal at 77"

TP611 depth 96" 0-13" Fill 13-20" Buried TS 20-38" Orange brown fine sandy loam 38-96" Gray brown sandy till w/rocks Mottled @ 36" Roots to 56" No refusal TP612 depth 76" - refusal? 0-3" Leaf litter & TS 3-18" Orange brown silty sand 18-76" Yellow to gray brown compact sandy tillw/rocks

No apparent redox

Roots to 59"

Roots to 40"

Refusal

Refusal @ 76"

TPS13 depth 70" - refusal 0-4" Leaf litter &TS 4-24" Yellow brown sandy loam 24-70" Compact yellow brown sandy till w/rocks No apparent redox

Perc Tests
237 UPPER PATTAGANSETT ROAD East Lyme Connecticut Date: NOVEMBER 2, 2024 Weather Conditions 62 Degrees-Dry Lot 32-5 Test No. 601 Hole Depth 24" Pre soak-4:30 pm-11/1-Dry- 1:00 pm-11/2 1:15 (refill hole 12") 50 minutes Lot 32.5 Test No. 603 Hole Depth 24" Pre soak-4:30 pm-11/1-Dry 1:00 pm-11/2 24.0" 19.0." 17.25" 15.75" 14.75" 9.25"


	Perc Tests UPPER PATTAGANSET East Lyme Connectict Date: NOVEMBER 2, 20 ather Conditions 62 Degre	it)24
Lot 32-4 Test No. 606 Hole Depth 24"		
Pre soak-4:10 pm-11/1-Dry- 1	:00 pm-11/2	
	Reading	Drop
1:00 (refill hole 12")	24.0"	n/a
1:20	21.0"	3.0"
1:30	19.0 "	2.0"
1:40	17.5"	1.5"
1:50	16.0"	1.0"
2:00	15.0"	1.0"
2:10	<u>14.25"</u>	75"
70 minutes		9.25"
Lot 32.4 Test No. 604 Hole Depth 24"		
Pre soak-4:10 pm-11/1-Dry 1:	00 pm-11/2	
	Reading	Drop
1:00 (refill hole 12")	24.0"	n/a
1:10	20.0."	4.0"
1:20	18.0"	2.0"
1:30	16.5"	1.5"
1:40	15.0"	1.5"
40 minutes		9.0"


	East Lyme Connecticu Date: NOVEMBER 2, 20 ther Conditions 58 Degre	24
Lot 32-3 Test No. 608 Hole Depth 24"		
Pre soak-3:30 pm-11/1-Dry-10:	00 am-11/2	
	Reading	Drop
10:10 (refill hole 12")	24.0"	n/a
10:20	20.0"	4.0"
10:30	18.0 "	2.0"
10:40	16.5"	1.5"
10:50	15.25	1.25"
11:00	14.25	<u>1.0"</u>
50 minutes		9.75"
Lot 32.3 Test No. 609 Hole Depth 24"		
Pre soak-3:35 pm-11/1-Dry 10:	00 am-11/2	
	Reading	Drop
10:10 (refill hole 12")	24.0"	n/a
10:20	20.0."	4.0"
10:30	17.5"	2.5"
10:40	16.0"	1.5"
10:50	14.5"	1.5"
40 minutes		9.5"

P = design precipitation, inches (1.3" for water quality storm) A = drainage area (acres) roof area 2,200 sf >> 0.045 acV = runoff volume CFV = (1.3"/12)ft x 2200 sf = 200 CF Rain Garden size 10-feet wide X 20 -feet long x 1'3"- deep= 250CF

Water Quality Volume rainfall event 1.3" WQV rainfall

Rain Gardens

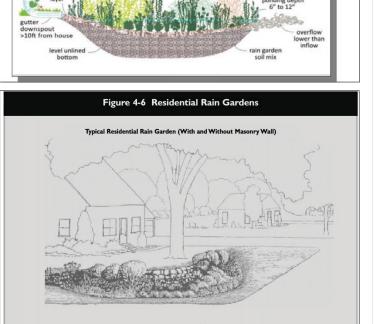

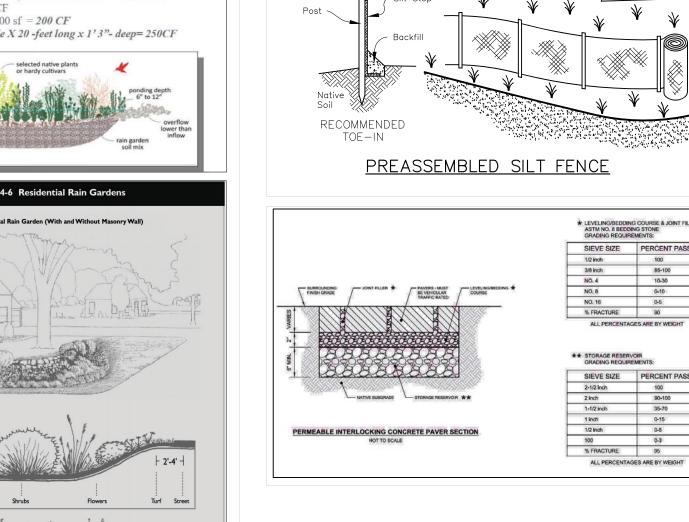

SOIL EROSION & SEDIMENTATION CONTROL NOTES

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Any proposed vegetation which has not survived one growing season will be replaced. All suitable material excavated for roadway construction to be used elsewhere on site.

All construction activity to occur between March 15 and October 15 to avoid adverse impacts on downstream flows.

Unsuitable material will be removed from the site and deposited in a suitable location.

Less than (1/2) of an acre of disturbance is proposed foreach lot.



May Engineering LLC

Civil Engineering and Site Planning 1297 RT 163 Oakdale, CT 06370 860 884-9671


PLAN SHOWING PROPERTY OF ENGLISH HARBOR CAPITAL PARTNERS, LLC

237 Upper Pattegansett Rd. EAST LYME, CONNECTICUT

Lots:	#32-3, 32-4, 32-5
Lot Grading L	ayout Plan and E&9

NOTTINGHAM HILLS SUBDIVISION SCALE: 1"=30' DATE: 27 August 2025 Rev 09/04/25

JOB NUMBER SHEET 3 of 3 Lot Grading, Layout Plan and E&S Plan

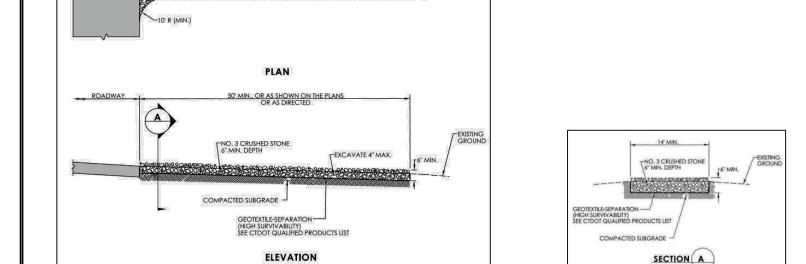

ANTI-TRACKING PAD