

-LENGTH OF STREAM/WETLANDS TO BE ALTERED = 50 LINEAR FEET (MAX.)-

HORIZONTAL DISTANCE (FT.)

0 + 30

0+20

0+10

0+00

0 + 40

0+70

0+60

0+50

PLAN

DREDGING STREAM MAINTENANCE

FEBRUARY 6, 2024 SCALE: 1"=10' DRAWN BY:

CHECKED BY: DWG. NO.: SMDP-1 SHEET NO.:

50 L.F. (MAX.)

700± S.F. (0.016 AC.)

30± CU. YD.

800± S.F. (0.018 AC.)

TOTAL LENGTH OF STREAM/WETLAND DISTURBED

TOTAL AREA STREAM/WETLAND DISTURBED

TOTAL VOLUME OF SEDIMENT TO BE

REMOVED FROM STREAM/WETLANDS

TOTAL AREA OF UPLAND DISTURBED

1 of 2 JOB. NO.: 2023-971

SOIL EROSION & SEDIMENTATION CONTROL PLAN NARRATIVE

THE SITE CONTRACTOR MUST FOLLOW ALL GUIDELINES SET FORTH IN THE MANUAL ENTITLED "2002 CONNECTICUT GUIDELINES FOR SOIL EROSION AND SEDIMENT CONTROL" PUBLISHED BY THE CONNECTICUT COUNCIL ON SOIL AND WATER CONSERVATION IN COOPERATION WITH THE CONNECTICUT DEPARTMENT OF ENVIRONMENTAL PROTECTION. THIS MANUAL IS ALSO KNOWN AS DEP

PROJECT DESCRIPTION

THERE IS AN EXISTING 2'x4' BOX CULVERT AND CATCH BASINS THAT DRAIN TO A STREAM ALONG CHAPMAN WOODS ROAD, AS SHOWN. OVER TIME, SEDIMENT AND DISLODGED RIPRAP HAS ACCUMULATED AT THE DRAINAGE SYSTEM OUTLET PIPE ADVERSELY EFFECTED THE FLOW OF THE DRAINAGE SYSTEM AND CAUSING THE OUTLET PIPE OF THE NEAREST DOWNSTREAM CATCH BASIN O BECOME BURIED. THE APPLICANT IS PROPOSING TO REMOVE THE ACCUMULATED SEDIMENT TO RESTORE THE FLOW OF THE STREAM TO ITS ORIGINAL CONDITION AND TO ALLOW THE ROADWAY DRAINAGE SYSTEM TO DRAIN PROPERLY. A TEMPORARY STONE CHECK DAM BERM IS ALSO PROPOSED TO CONTAIN ANY SEDIMENT DURING CONSTRUCTION.

CONSTRUCTION IS ANTICIPATED TO COMMENCE IN LATE WINTER/EARLY SPRING 2024 AND SHALL BE DONE DURING AN EXTENDED DRY PERIOD. A STONE CHECK DAM BERM SHALL BE INSTALLED PRIOR TO CONSTRUCTION ACTIVITIES AND SHALL BE REMOVED IN ITS ENTIRETY AFTER CONSTRUCTION. ALL DISTURBED AREAS SHALL BE LOAMED, SEEDED AND MULCHED AS NECESSARY OR OTHERWISE RESTORED TO THEIR ORIGINAL CONDITION OR BETTER. SILT FENCE OR STRAW WATTLES SHALL BE USED AROUND THE AREA TO PREVENT SILTATION TO THE STREAM OR ROAD AND SHALL BE REMOVED AS SOON AS THE TOWN WETLANDS AGENT DEEMS THE AREA ADEQUATELY STABILIZED. ALL E&S CONTROLS SHALL BE MAINTAINED AND REPAIRED OR REPLACED AS NEEDED THROUGHOUT THE CONSTRUCTION DURATION.

CONSTRUCTION SEQUENCE

- 1. CONTACT "CALL BEFORE YOU DIG" TO MARK OUT ALL UTILITY LOCATIONS PRIOR TO ANY CONSTRUCTION ACTIVITIES.
- 2. ENSURE ALL LAND USE PERMITS HAVE BEEN SECURED. OBTAIN ALL NECESSARY PERMITS.
- 3. INSTALL TEMPORARY STONE CHECK DAM BERM DOWNSTREAM OF THE WORK AREA.
- 4. REMOVE ACCUMULATED SEDIMENT FROM THE STREAM/WETLANDS AND HAUL OFF SITE IMMEDIATELY. 5. REGRADE STREAM SO IT HAS POSITIVE PITCH WITH A MINIMUM SLOPE OF 1.5%± (RESTORE ORIGINAL CONDITIONS).
- 6. REMOVE TEMPORARY STONE CHECK DAM BERM.
- 7. INSPECT AND CLEAN THE CATCH BASINS, SUMPS, AND PIPES WITHIN THE PROPOSED WORK AREA.
- 8. INSTALL SILT BARRIER AS SHOWN ON SITE PLAN.
- 9. LOAM, SEED AND MULCH DISTURBED UPLAND AREAS AS REQUIRED. NO PESTICIDES OR NON-ORGANIC FERTILIZERS SHALL BE USED.
- 10. REMOVE SILT BARRIER WHEN SITE HAS BEEN DEEMED STABILIZED BY TOWN WETLANDS OFFICER.

LAND DISTURBANCE

- 8. ALL CONSTRUCTION EQUIPMENT AND MATERIALS SHALL NOT BE PLACED OUTSIDE OF THE DISTURBED AREAS.
- 9. REMOVED SEDIMENT SHALL NOT BE STOCKPILED ON SITE AND SHALL BE HAULED OFF SITE IMMEDIATELY.

SOIL EROSION AND SEDIMENT CONTROLS

ALL ADJACENT PROPERTIES AND RECEIVING WATERCOURSES AND/OR WETLAND AREAS SHALL BE ADEQUATELY PROTECTED FROM SOIL EROSION AND SEDIMENTATION BOTH DURING AND AFTER CONSTRUCTION.

ADDITIONAL EROSION AND SEDIMENT CONTROLS MAY BE REQUIRED BY THE TOWN OF EAST LYME AND SHALL BE INSTALLED AND MAINTAINED BY THE CONTRACTOR. THE CONTRACTOR SHALL BE RESPONSIBLE FOR THE PROPER INSTALLATION AND MAINTENANCE OF ALL EROSION AND SEDIMENT CONTROLS BEFORE, DURING AND AFTER CONSTRUCTION. THE CONTRACTOR IS ALSO RESPONSIBLE FOR THE PROPER REMOVAL AND DISPOSAL OF ALL EROSION AND SEDIMENT CONTROLS ONCE THE SITE IS COMPLETELY STABILIZED.

ALL EROSION AND SEDIMENT CONTROLS SHALL BE INSPECTED WEEKLY AND AFTER ALL RAINFALL EVENTS. E&S CONTROLS SHALL BE REPAIRED OR REPLACED AS NECESSARY WITHIN 24 HOURS THROUGHOUT THE CONSTRUCTION DURATION.

ALL ACCUMULATED SEDIMENTS AT ALL EROSION AND SEDIMENT CONTROLS SHALL BE PERIODICALLY REMOVED AND SPREAD IN AREAS THAT ARE NOT SUBJECT TO EROSION.

THE CONTRACTOR SHALL EMPLOY BEST MANAGEMENT PRACTICES TO CONTROL STORMWATER DISCHARGES AND TO PREVENT EROSION AND SEDIMENTATION AND TO OTHERWISE PREVENT POLLUTION OF WETLANDS OR WATERCOURSES OR PRIVATE PROPERTY. THE CONTRACTOR SHALL IMMEDIATELY INFORM THE TOWN OF EAST LYME OF ANY PROBLEMS INVOLVING EROSION AND/OR SEDIMENTATION THAT HAVE DEVELOPED IN THE COURSE OF, OR THAT ARE CAUSED BY, THE AUTHORIZED WORK.

THE RESPONSIBLE CONTACT PERSON FOR THE INSTALLATION AND MAINTENANCE OF EROSION AND SEDIMENTATION CONTROLS ON THIS PROJECT WILL BE THE SITE CONTRACTOR AND/OR THE GENERAL CONTRACTOR. ONCE THE GENERAL CONTRACTOR IS SELECTED, CONTACT INFORMATION WILL BE PROVIDED TO THE TOWN.

VEGETATIVE TURF ESTABLISHMENT PROCEDURE

SCARIFY ALL AREAS TO BE TOPSOILED AND SEEDED. APPLY A MINIMUM OF 4 INCHES OF TOPSOIL ON ALL AREAS TO BE SEEDED. APPLY GRASS SEED, LIME, FERTILIZER AND MULCH ACCORDING TO THE FOLLOWING SCHEDULE:

PERMANENT SEED MIXTURE:

0.45 LBS. PER 1,000 SQ. FT. CREEPING RED FESCUE

REDTOP 0.05 TALL FESCUE 0.45

TOTAL FERTILIZER:

10-10-10 APPLY AT 7.5 LBS. PER 1,000 SQ. FT.


0.95


APPLY AT 150 LBS. PER 1,000 SQ. FT.

SPREAD HAY OR STRAW OVER ALL AREAS AFTER SEEDING. USE 1 1/2 TO 2 BALES PER 1,000 SQ. FT. TARGET FOR 100% COVERAGE. ANCHOR BY USING NETTING OR TRACKING AS NECESSARY.


TEMPORARY EROSION CONTROL BLANKETS: USE TEMPORARY EROSION CONTROL BLANKETS ON ALL SEEDED SLOPES STEEPER THAN 3 (H) TO 1 (V) AND/OR AS DIRECTED BY THE DESIGN ENGINEER.

SEEDING DATES IN CONNECTICUT ARE NORMALLY APRIL 1 THROUGH JUNE 15 AND AUGUST 15 THROUGH OCTOBER 1. SEED GERMINATION NORMALLY CANNOT BE EXPECTED FROM NOVEMBER THROUGH FEBRUARY. IF ADEQUATE SEED GERMINATION IS NOT POSSIBLE DUE TO TIME OF YEAR CONSTRAINTS, MULCHING SHALL BE ADEQUATELY PROVIDED TO PROTECT THE SEED FROM WIND AND SURFACE EROSION UNTIL THE WEATHER IMPROVES AND THE SEEDING BECOMES WELL ESTABLISHED.

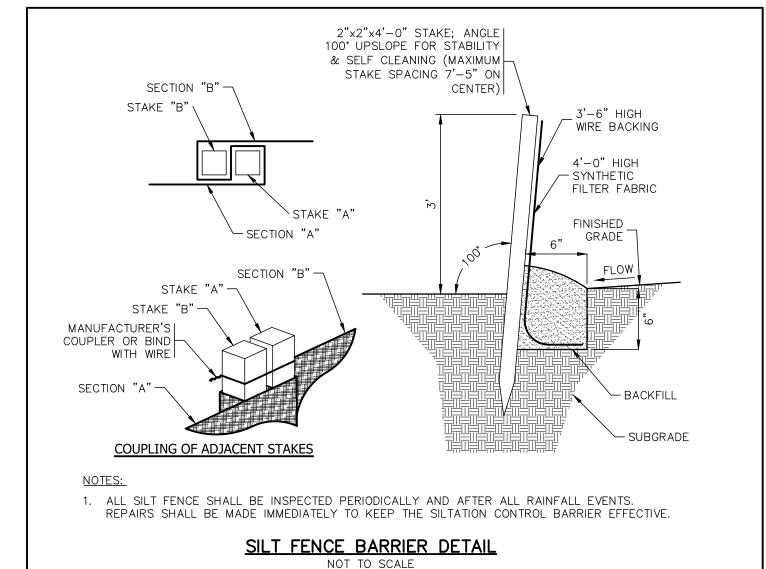

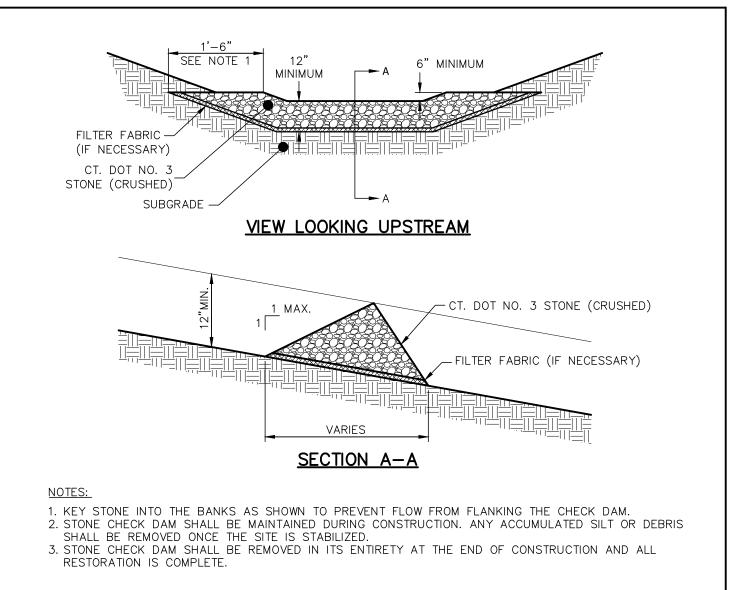

STONE CHECK DAM BERM DETAIL

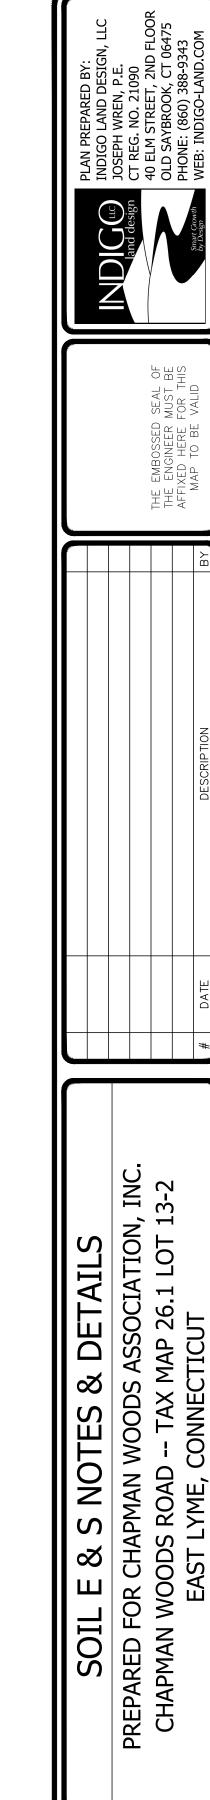

FEBRUARY 6, 2024 SCALE: AS NOTED DRAWN BY: CHECKED BY:

DWG. NO.: SES-1

SHEET NO .: 2 of 2JOB. NO.: 2023-971