

1. THIS PLAN AND THE SURVEY IT IS BASED ON HAVE BEEN PREPARED IN ACCORDANCE WITH THE REGULATIONS OF CONNECTICUT STATE AGENCIES, SECTIONS 20—300B MINIMUM STANDARDS OF ACCURACY, CONTENT AND CERTIFICATION FOR SURVEYS AND MAPS. THE TYPE OF SURVEY IS A PROPERTY SURVEY, THE BOUNDARY DETERMINATION CATEGORY IS A RESURVEY FOR THE PERIMTERE BOUNDARY AND A FIRST SURVEY FOR THE NEW OT LAYOUT. THE HORIZONTAL ACCURACY CONFORMS TO CLASS A-2.

NO DECLARATION IS EXPRESSED OR IMPLIED BY THIS MAP OR COPIES THEREOF UNLESS THE PRINT BEARS THE IMPRESSION TYPE SEAL AND ORIGINAL LIVE SIGNATURE OF THE SURVEYOR WHOSE NAME AND REGISTRATION

2. REFERENCE IS MADE TO EAST LYME LAND EVIDENCE RECORDS VOLUME 1100 AT PAGE 336 FOR A WARRANTY DEED DATED AUGUST 4, 2023 REGARDING RECORD TITLE TO THE SUBJECT PROPERTY.

3. THE PROPERTY SHOWN HEREON IS SUBJECT TO THE FOLLOWING:

SEE VOLUME 131 AT PAGE 175 FOR AN EASEMENT CONVEYED BY JAMES A ROLFE TO THE SOUTHERN NEW ENGLAND TELEPHONE COMPANY DATED JUNE 16, 1971. SEE VOLUME 131 AT PAGE 1 FOR AN EASEMENT CONVEYED BY JAMES A ROLFE TO THE CONNECTICUT LIGHT AND

4. THE SUBJECT PROPERTY IS LOCATED ENTIRELY WITHIN THE RU-40/20 ZONE DISTRICT.

- 5. BY GRAPHICAL DEPICTION ONLY, THIS PARCEL LIES WITHIN FLOOD HAZARD ZONE X AS SHOWN ON "NATIONAL FLOOD INSURANCE PROGRAM FLOOD INSURANCE RATE MAP NEW LONDON COUNTY, CONNECTICUT, COMMUNITY: TOWN OF EAST LYME MAP NUMBER: 09011C0479J MAP EFFECTIVE: 8-5-2013, FEDERAL EMERGENCY
- 6. THE SUBJECT PROPERTY IS SHOWN ON THE EAST LYME TAX ASSESSOR MAP 16.2 AS LOT 73 AND HAS AN ASSIGNED STREET ADDRESS OF 220 PENNSYLVANIA AVENUE.
- 7. BEARINGS AND COORDINATES NOTED HEREON ARE REFERENCED TO THE CONNECTICUT STATE PLANE COORDINATE SYSTEM (NAD 83) EPOCH 2011 (2010.0). ELEVATIONS DEPICTED HEREON ARE REFERENCED TO THE NORTH AMERICAN VERTICAL DATUM OF 1988 (NAVD88) TRANSFORMED FROM ELLIPSOID HEIGHT TO ORTHOMETRIC HEIGHT UTILIZING NGS2018 GEOID. AS DETERMINED BY GLOBAL POSITIONING SYSTEM (GPS) OBSERVATIONS UTILIZING THE SUPERIOR GNSS REFERENCE NETWORK STATION HAVING THE FOLLOWING VALUES:

LATITUDE = N41.303892795* LONGITUDE = W72.050613875* ELLIPSOID HEIGHT = -10.7997 METERS

- 8. THIS PLAN REPRESENTS THE LOCATION OF THE BOUNDS AND SITE CONDITIONS DETERMINED BY FIELD SURVEY ON AUGUAT 29, 2023. RECORD TITLE AND ADJOINER INFORMATION WAS OBTAINED FROM TAX ASSESSOR AND LAND
- 9. UNDERGROUND UTILITY, STRUCTURE AND FACILITY LOCATIONS DEPICTED AND NOTED HEREON HAVE BEEN COMPILED, IN PART, FROM RECORD MAPPING SUPPLIED BY THE RESPECTIVE UTILITY COMPANIES OR GOVERNMENTAL AGENCIES, FROM PAROLE TESTIMONY AND FROM OTHER SOURCES. THESE LOCATIONS MUST BE ONSIDERED AS APPROXIMATE IN NATURE. ADDITIONALLY, OTHER SUCH FEATURES MAY EXIST ON THE SITE, THE EXISTENCE OF WHICH ARE UNKNOWN TO JAMES BERNARDO LAND SURVEYING, LLC. THE SIZE, LOCATION AND EXISTENCE OF ALL SUCH FEATURES MUST BE FIELD DETERMINED AND VERIFIED BY THE APPROPRIATE AUTHORITIES PRIOR TO CONSTRUCTION. CALL BEFORE YOU DIG 1-800-922-4455.

MAP REFERENCES:

- 1. CONNECTICUT STATE HIGHWAY DEPARTMENT RIGHT OF WAY MAP TOWN OF EAST LYME PENNSYLVANIA AVE. NIANTIC FROM MAIN ST. NORTHERLY TO THE BLACK POINT ROAD SCALE 1"=40' NUMBER 44-04 SHEET 3 OF 3.
- 2. L.T. KISER SCALE 1"=40' MAY 5, 1964 STONINGTON CONN. BY PERCY L. ALLEN PE, LS (BOOK 7 PAGE 103).

SUBDIVISION NOTES: 1. TOTAL AREA OF SUBDIVISION = 185,992.94 SQUARE FEET OR 4.27 ACRES.

- 2. A WAIVER IS REQUESTED OF SECTION 6-17-1 (UNDERGROUND UTILITIES) TO ALLOW THE EXISTING OVER HEAD UTILITIES ALONG THE EASTERLY SIDE OF THE EXISTING DRIVEWAY TO REMAIN. ALL NEW UTILITIES FOR THE INDIVIDUAL HOUSES SHALL BE UNDERGROUND FROM THE EXISTING POLES.
- 3. IN ACCORDANCE WITH SECTION 23.6 OF THE ZONING REGULATIONS A MINIMUM OF 30% OF THE PROPERTY AREA SHALL BE OPEN SPACE IN A CONSERVATION DESIGN DEVELOPMENT. THE OPEN SPACE IS CALCULATED AS FOLLOWS: TOTAL PROPERTY AREA = 185,992.94 SQUARE FEET AREA OF OPEN SPACE = 97,083.1 SQUARE FEET

THEREFORE OPEN SPACE = 52% OF THE SUBDIVISION AREA.

PURSUANT TO THE TOWN OF EAST LYME SUBDIVISION REGULATIONS SECTION 4-2-3(J), OPEN SPACE IS BEING PROPOSED IN ACCORDANCE WITH SECTION 23.6 OF THE EAST LYME ZONING REGULATIONS IN THE FORM OF A CONSERVATION EASEMENT. THE PROPOSED DEDICATION OF OPEN SPACE COMPLIES WITH SECTION 23.6 IN THAT IT:

A. EXCEEDS THE MINIMUM REQUIRED OPEN SPACE DEDICATION BY MORE THAN 20%.

- B. NOT MORE THAN 50% OF THE LAND CONSISTS OF WETLANDS OR STEEP SLOPES ON THE PROPERTY AS DEFINED BY CGS, SECTION 22A-38 (15). IN FACT, THERE ARE NO WETLANDS OR STEEP SLOPES ON ANY PORTION OF THE OPEN SPACE.
- . ALL THE BUILDING LOTS IN THE DEVELOPMENT WILL HAVE REASONABLE ACCESS TO THE OPEN SPACE AS WILL BE OUTLINED IN THE DEEDS. COVENANTS, AND RESTRICTIONS FOR THE PROJECT. THESE DOCUMENTS WILL BE PROVIDED TO TOWN STAFF FOR REVIEW AND COMMENT AS REQUIRED BY THE REGULATIONS.
- D. UNFORTUNATELY, THERE IS NO EXISTING OPEN SPACE ON THE ADJOINING PROPERTIES. HOWEVER, THE PROPOSED OPEN SPACE IS CONTIGUOUS THROUGHOUT THE PROPERTY.

IN ACCORDANCE WITH THE TOWN OF EAST LYME SUBDIVISION REGULATIONS SECTION 7-3(D), IT IS THE INTENT OF THE PROPERTY OWNER TO CREATE A HOMEOWNER'S ASSOCIATION IN ACCORDANCE WITH STATE OF CONNECTICUT LAW. THE CONSERVATION EASEMENT WILL BE DEDICATED TO THE HOMEOWNER'S ASSOCIATION. PROPERLY EXECUTED LEGAL DOCUMENTS SHALL BE PREPARED AND APPROVED BY THE TOWN ATTORNEY AND/OR THE COMMISSION PRIOR TO RECORDING.

4. THE DEEDS FOR ALL SHALL INCLUDE ALL INFORMATION REGARDING EASEMENTS, RIGHTS AND RESPONSIBILITIES REGARDING THE USE AND MAINTENANCE OF THE SHARED DRIVEWAY.

APPROVED BY THE EAST LYME PLANNING COMMISSION CHAIRMAN/SECRETARY APPROVAL DATE FILING DATE **EXPIRATION DATE** EROSION AND SEDIMENT CONTROL PLAN CERTIFIED BY VOTE OF EAST LYME PLANNING COMMISSION ON CHAIRMAN/SECRETARY

SOILS LEGEND

29B AGAWAM FINE SANDY LOAM, 3 TO 8 PERCENT SLOPES

34C MERRIMAC FINE SANDY LOAM, 8 TO 10 PERCENT SLOPES

38E HINCKLEY LOAMY SAND, 15 TO 45 PERCENT SLOPES

61B CANTON AND CHARLTON FINE SANDY LOAMS, 0 TO 8 PERCENT SLOPES, VERY STONY

73C CHARLTON-CHATFIELD COMPLEX, 0 TO 15 PERCENT SLOPES, **VERY ROCKY**

75E HOLLIS-CHATFIELD-ROCK OUTCROP COMPLEX, 15 TO 45 PERCENT SLOPES

61B

N 80°22'56" W_

42.81'

Dodgetown Condominiums

81 East Pattagansett Road

N 81°25'08" W

N 83°19'25" W_

(IN FEET)

1 inch = 40 ft.

55.79'

OWNER/APPLICANT:

PETRIT MARKU

57 E. MAIN STREET MYSTIC, CT 06355 860-235-8500

SURVEYOR:

JAMES BERNARDO LAND

SURVEYING, LLC JAMES BERNARDO, LS 102A SPITHEAD ROAD WATERFORD, CT 06385

860-447-0236

INDEX TO SHEETS

OVERALL BOUNDARY & NATURAL & CULTURAL RESOURCES

LOT LAYOUT


SITE DEVELOPMENT

ALTERNATE - SITE DEVELOPMENT

SUBDIVISION DETAILS

SITE LINE DEMONSTRATION WATERSHED ANALYSIS

LOT YIELD PLAN

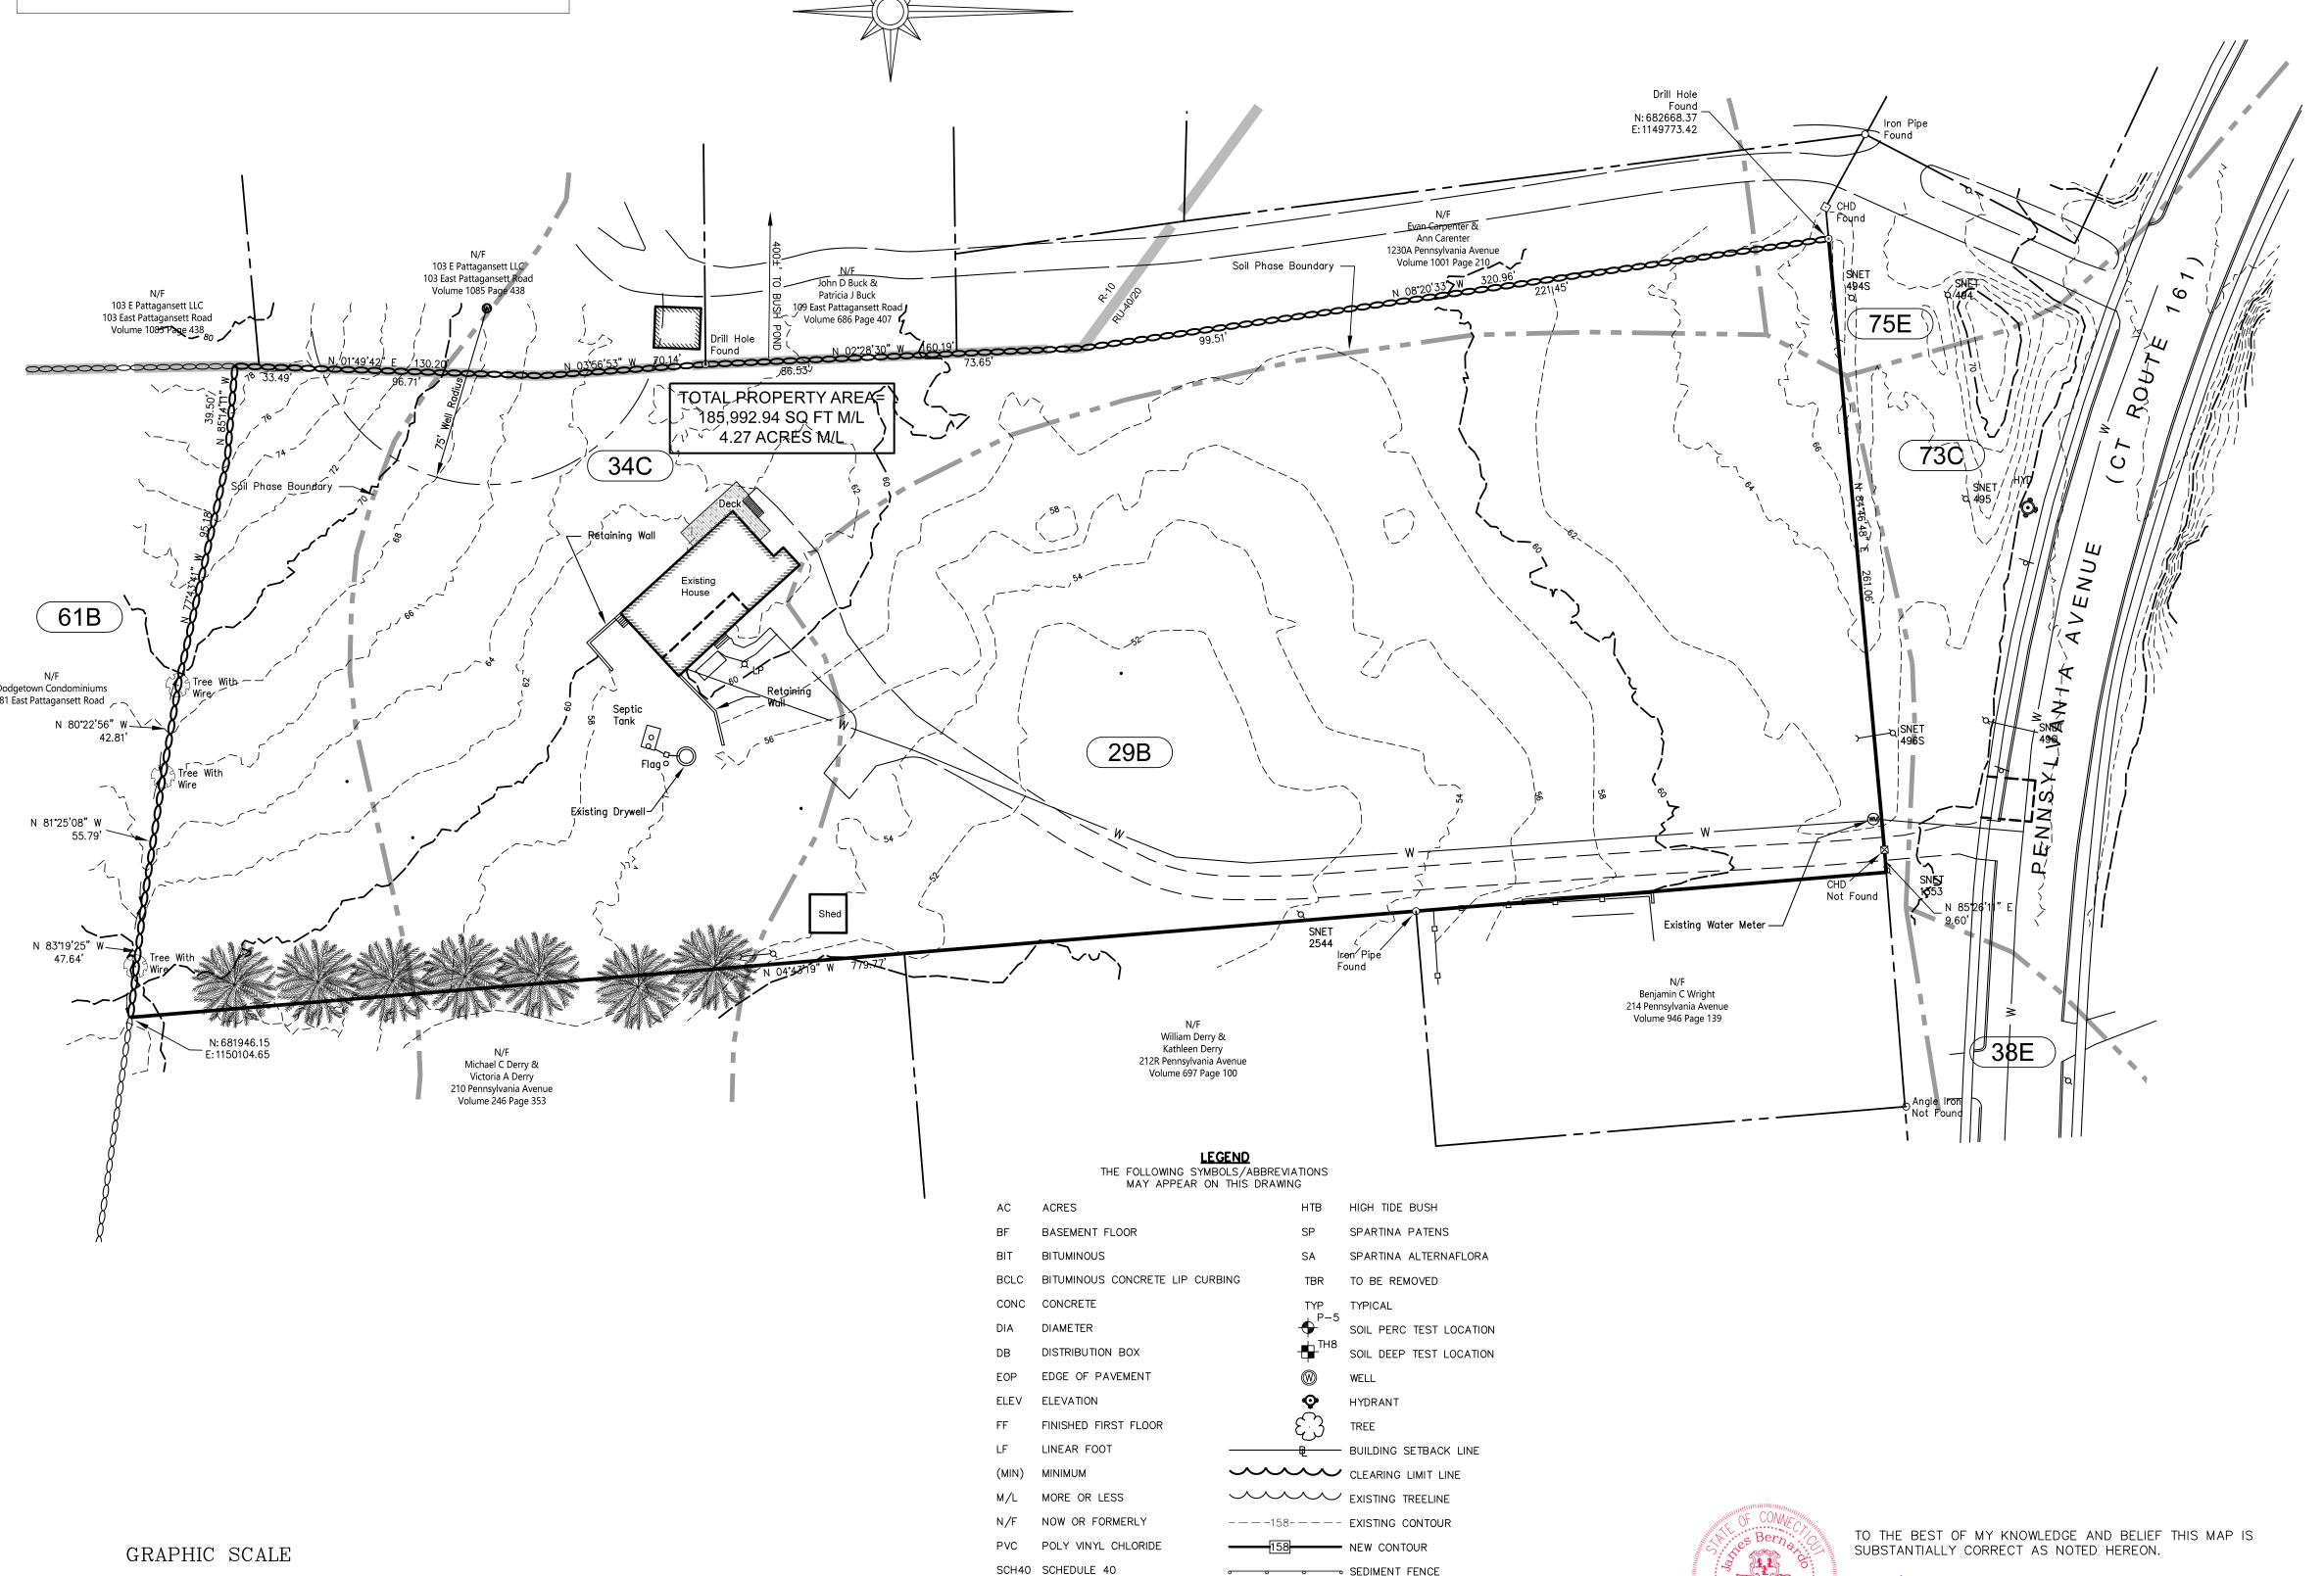

SEDIMENT FENCE

S S SANITARY SEWER

STONE WALL

----- W ----- WATER

- - - - STORM DRAIN PIPE

5.4x SPOT ELEVATION

SF SQUARE FEET

TR TO REMAIN



SUBDIVISION NOTE 3 SEPTIC LOCATED |WATER NOTES AND E&S | 12-3-2023 DESCRIPTION DATE **REVISIONS**

Sheet No.

SHEET 1 OF 8


1" =40'

1-4-2023

JAMES BERNARDO LICENSE #70121

SEPTEMBER 25, 2023

ZONING COMPLIANCE CHART ZONE: RU-40/20 ZONING REGULATIONS SECTION 23 CONSERVATION DESIGN DEVELOPMENT	
FRONT YARD SETBACK (MINIMUM)	10'
REAR YARD SETBACK (MINIMUM)	30'
REAR YARD SETBACK (WHEN ALONG PERIMETER OF CDD DEV)	50'
SIDE YARD SETBACK (MINIMUM)	15'
SIDE YARD SETBACK (WHEN ALONG PERIMETER OF CDD DEV)	50'
LOT COVERAGE (MAXIMUM)	25%
BUILDING SETBACK TO WETLANDS/WATERCOURSES	100'

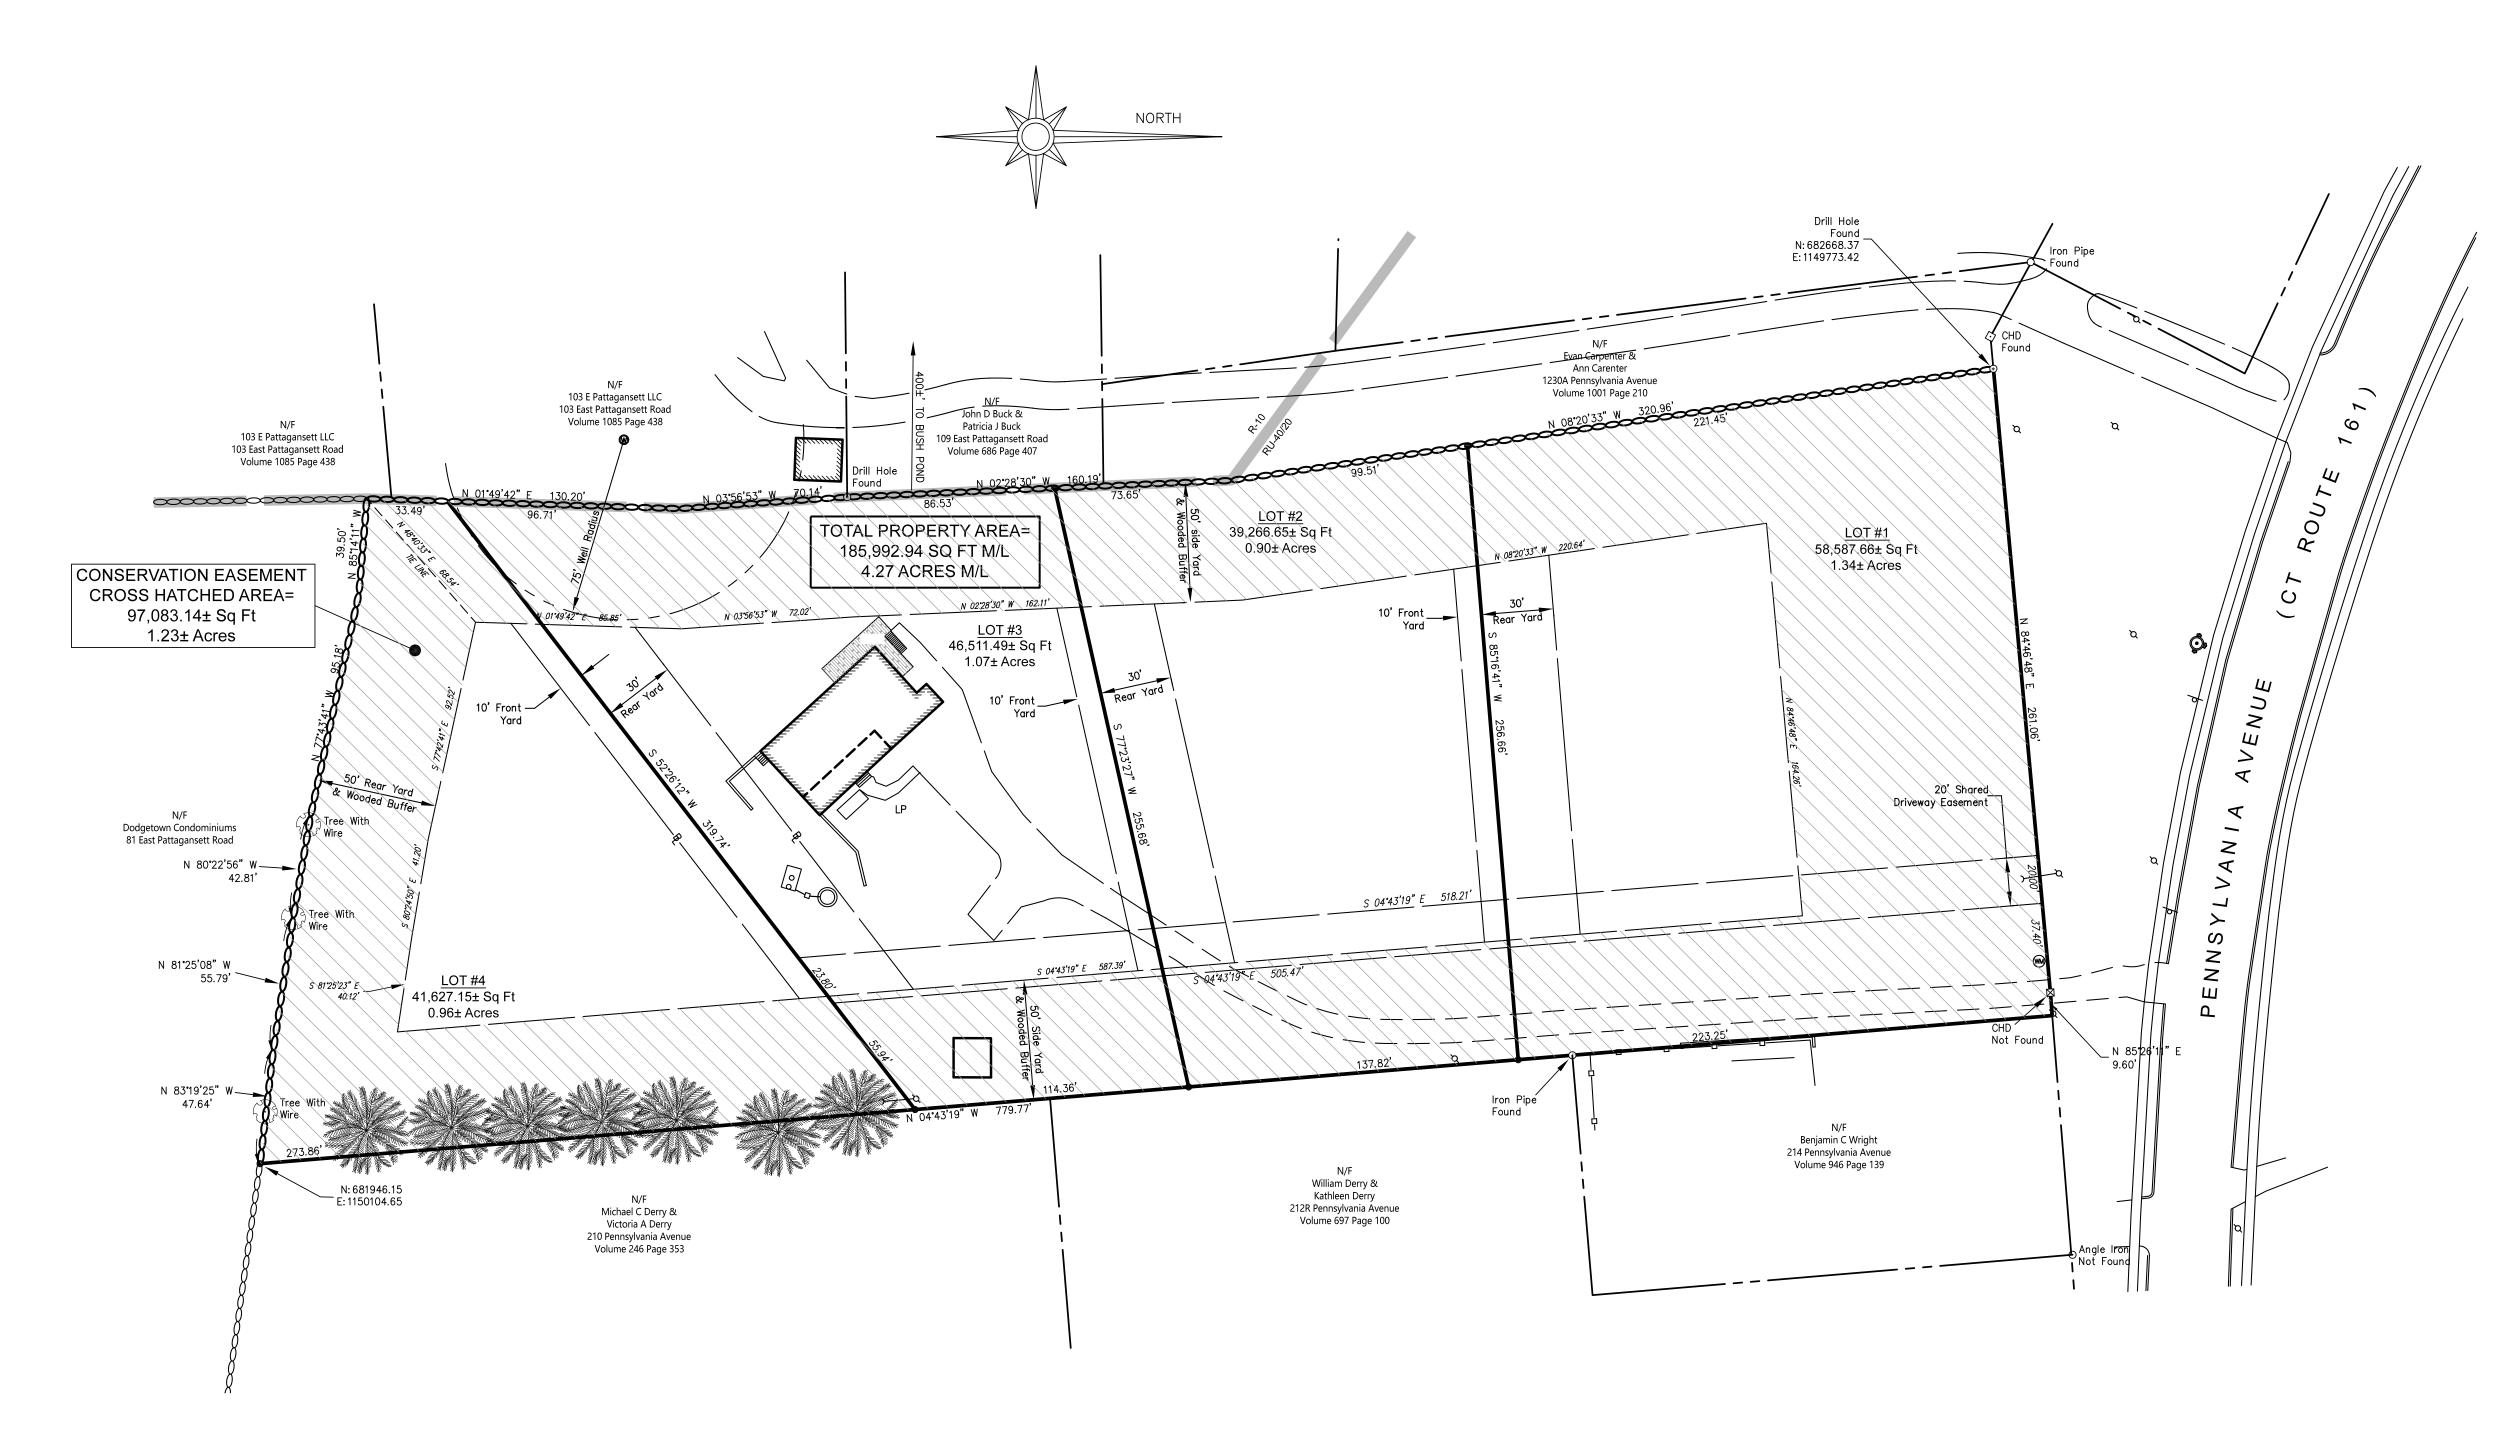

GRAPHIC SCALE (IN FEET) 1 inch = 40 ft.

JAMES BERNARDO
LAND SURVEYING, LLC
102A SPITHEAD ROAD
TERFORD, CONNECTICUT 0
(860) 447-0236
WWW.JBSURVEY.COM

EXISTING SEPTIC TEST HOLES, DRAINAGE WATER NOTES AND E&S 12-3-2023 ADDED

DESCRIPTION DATE REVISIONS 61

Sheet No.


SHEET 2 OF 8

PENNS'

220 TOWI


1" =40'

Date SEPTEMBER 25, 2023

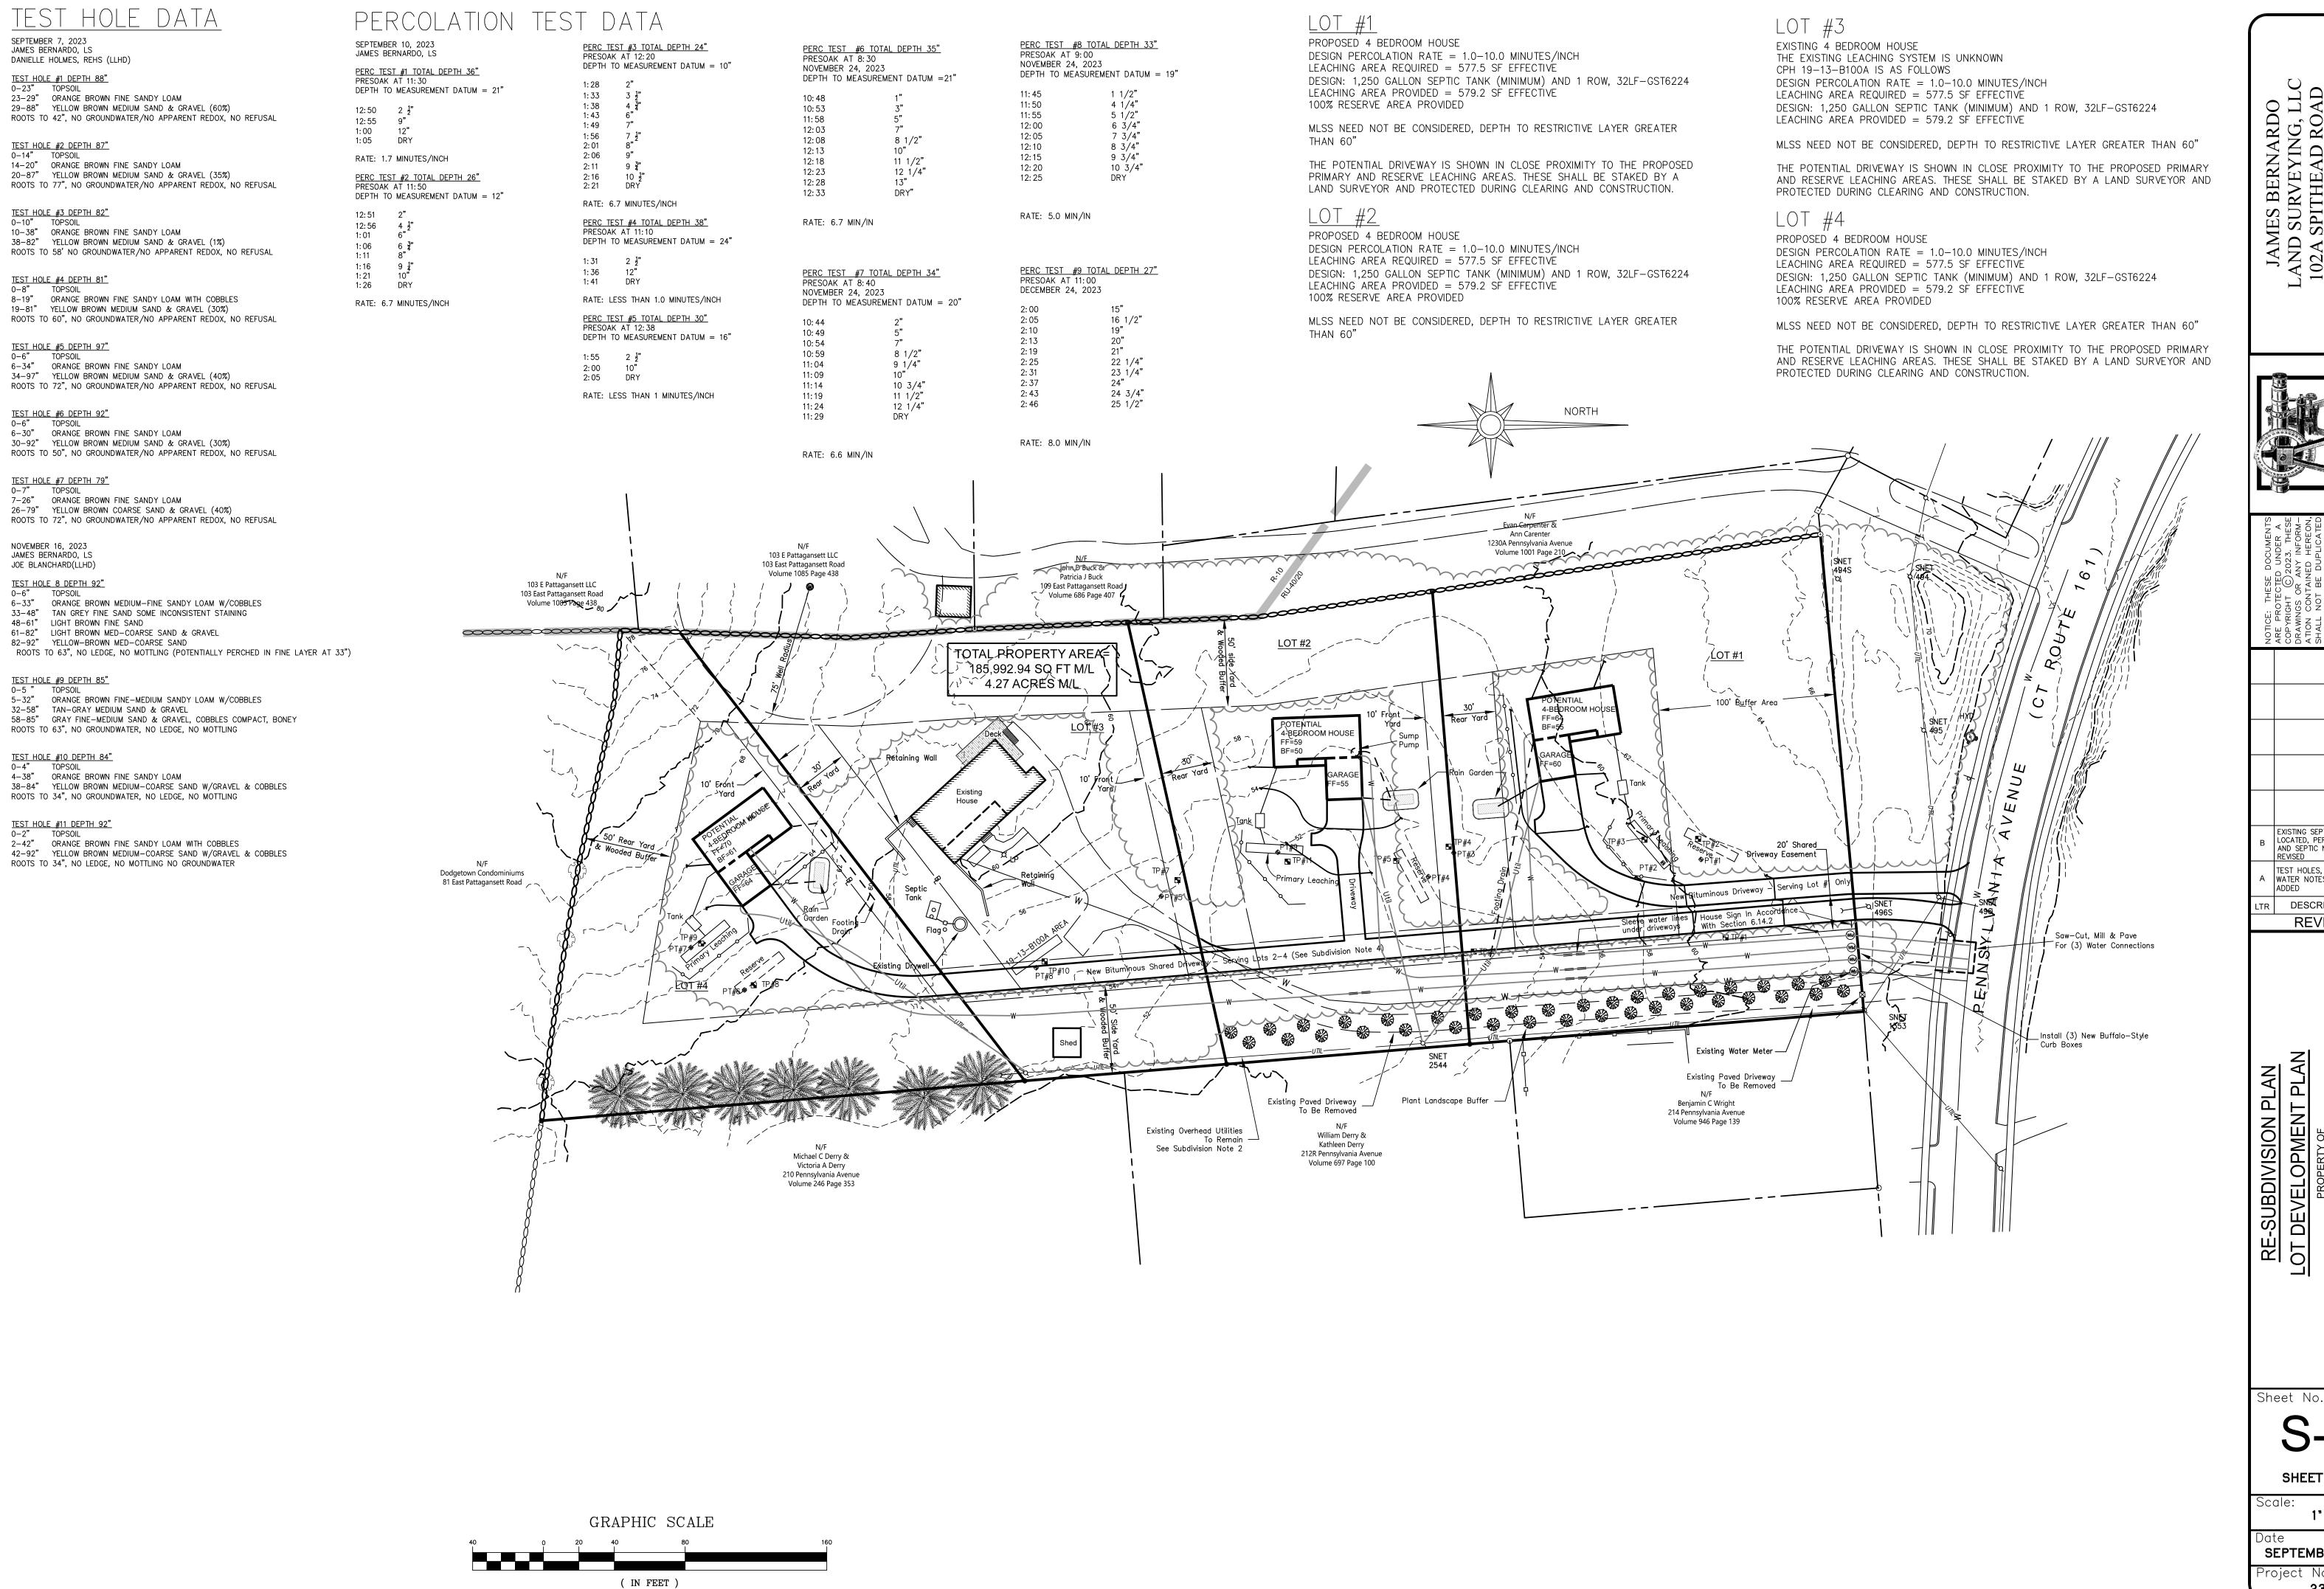

1 inch = 40 ft.

06385 JAMES BERNARDO
LAND SURVEYING, LLC
102A SPITHEAD ROAD
TERFORD, CONNECTICUT 0
(860) 447-0236
WWW.JBSURVEY.COM

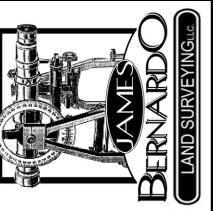


EXISTING SEPTIC OCATED, PERC TESTS AND SEPTIC NOTES REVISED TEST HOLES, DRAINAGE WATER NOTÉS AND E&S 1 DESCRIPTION DATE REVISIONS

9


SHEET 3 OF 8

1" =40'

SEPTEMBER 25, 202

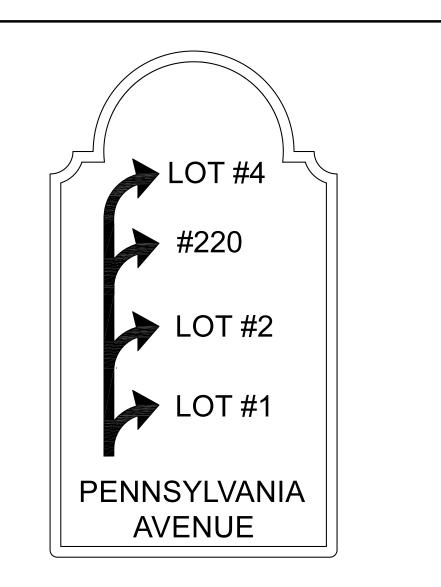

TYPICAL HOUSE NUMBER SIGN IN ACCORDANCE WITH SECTION 6-14-2. ACTUAL SIGN DESIGN MAY VARY. (LOT NUMBERS TO BE REPLACED WITH HOUSE NUMBERS)

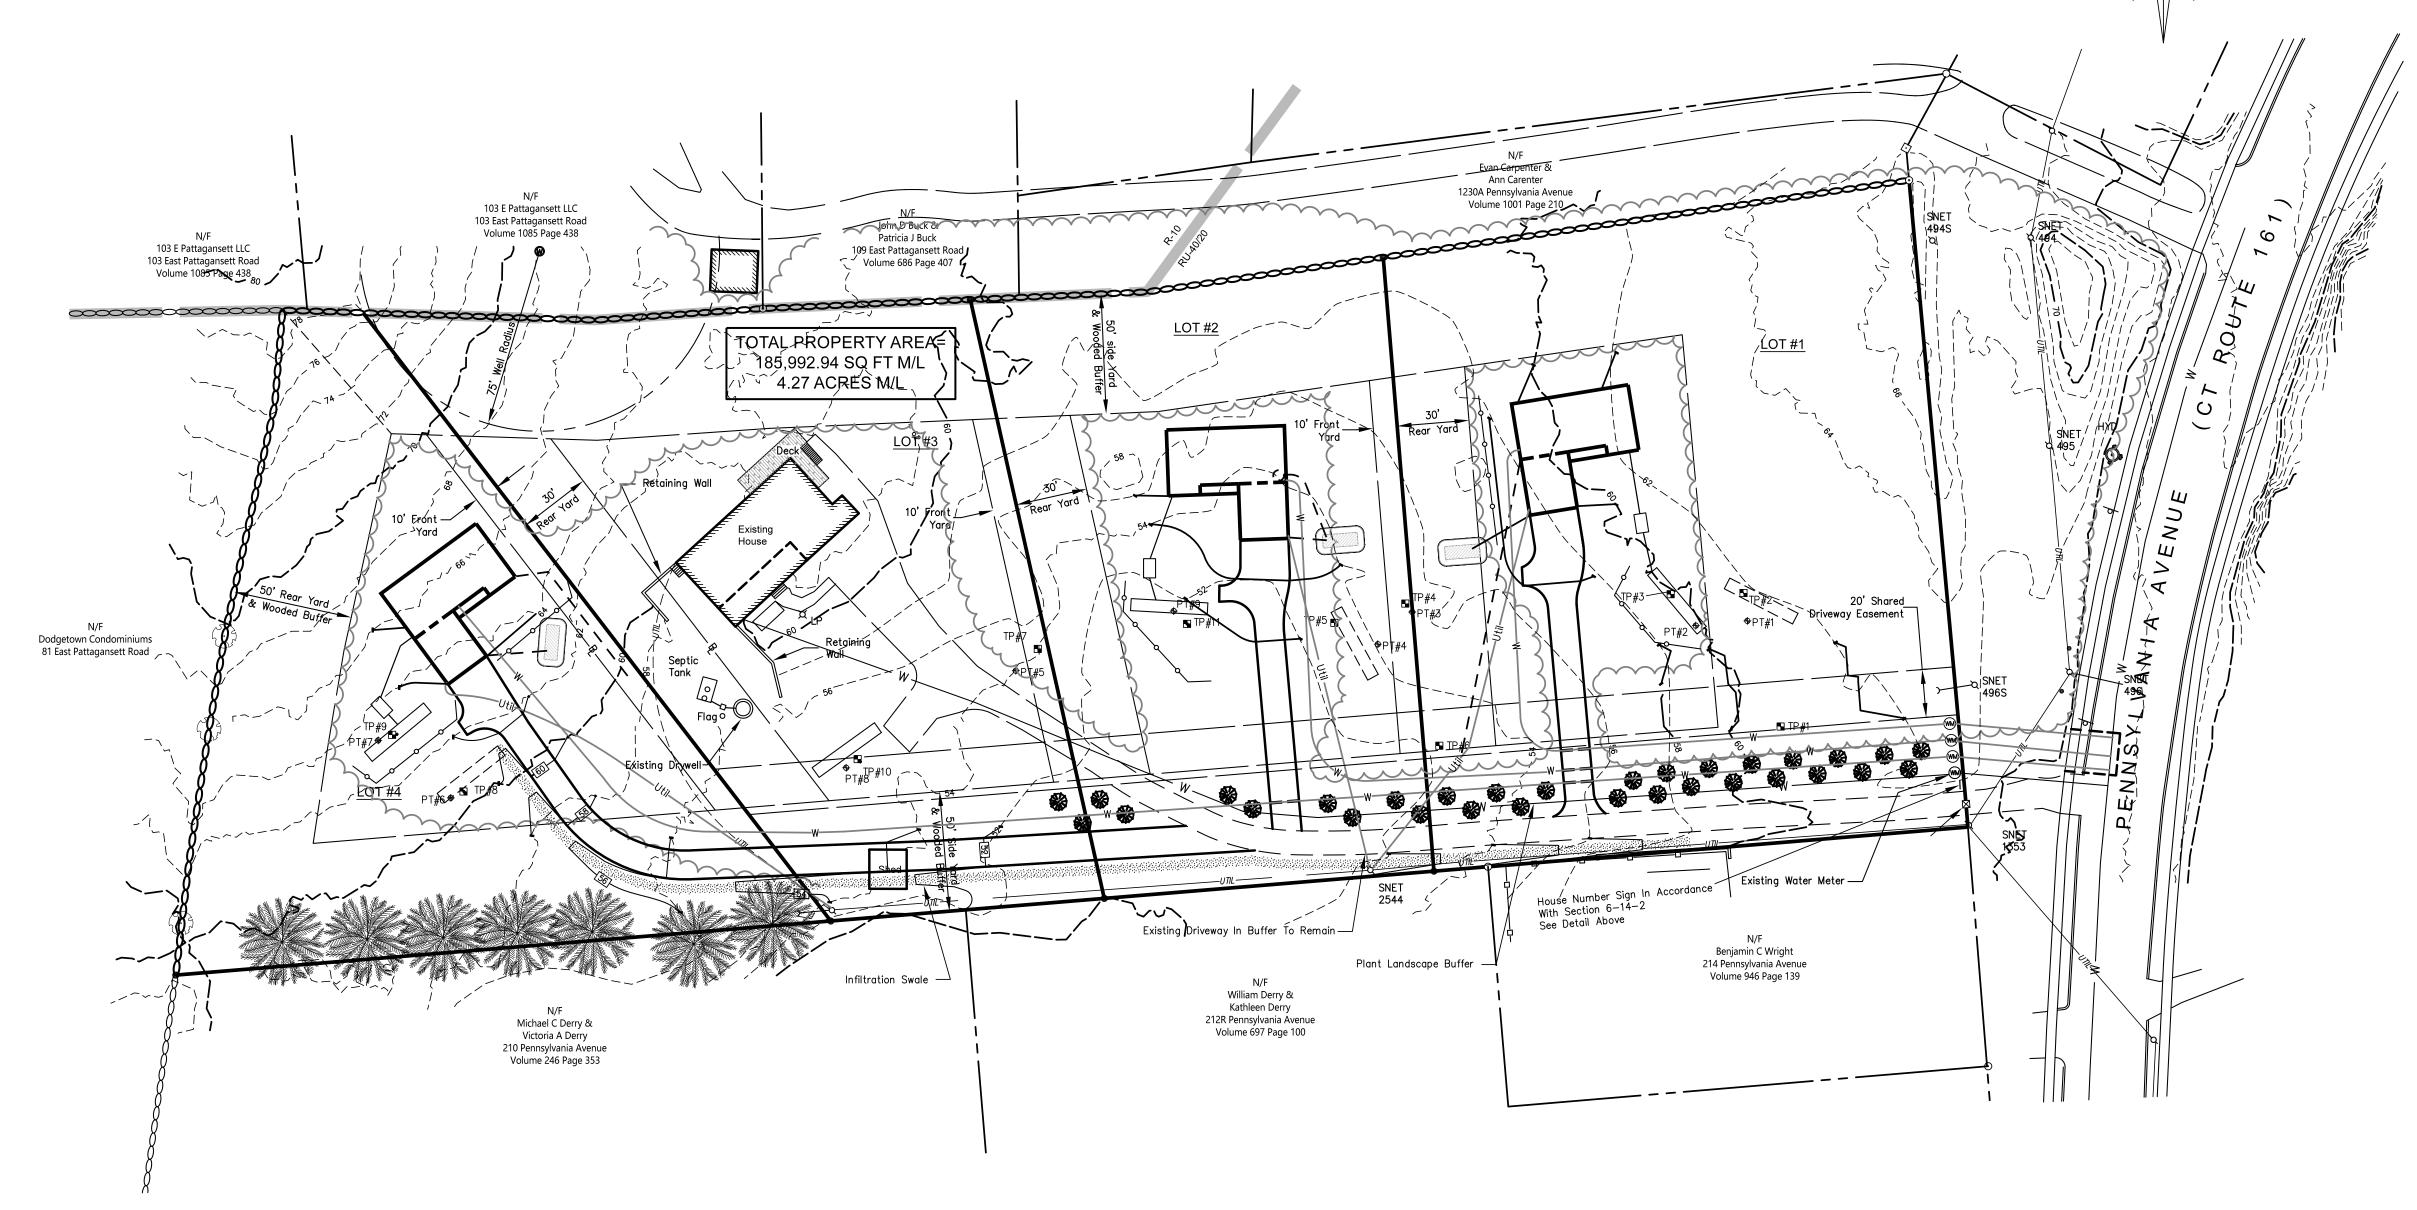

LEGEND THE FOLLOWING SYMBOLS/ABBREVIATIONS MAY APPEAR ON THIS DRAWING

AC ACRES HTB HIGH TIDE BUSH SPARTINA PATENS SA SPARTINA ALTERNAFLORA BCLC BITUMINOUS CONCRETE LIP CURBING TBR TO BE REMOVED TYPICAL SOIL PERC TEST LOCATION TH8 SOIL DEEP TEST LOCATION DB DISTRIBUTION BOX EOP EDGE OF PAVEMENT HYDRANT

TREE BUILDING SETBACK LINE

CLEARING LIMIT LINE EXISTING TREELINE M/L MORE OR LESS N/F NOW OR FORMERLY ----158---- EXISTING CONTOUR 158 NEW CONTOUR PVC POLY VINYL CHLORIDE


SCH40 SCHEDULE 40 SEDIMENT FENCE 5.4x SPOT ELEVATION - - - - - STORM DRAIN PIPE SF SQUARE FEET STONE WALL TR TO REMAIN S SANITARY SEWER

----- W ----- WATER

(IN FEET) 1 inch = 40 ft. NOTE:

THIS ALTERNATE LOT DEVELOPMENT LAYOUT IS PROVIDED TO DEMONSTRATE THAT THE CONTINUED USE OF THE EXISTING PAVED DRIVEWAY WITHIN THE REQUIRED BUFFER (23.5B) WOULD CREATE SIGNIFICANTLY LESS IMPACT TO THE SITE. SUCH USE WOULD OBVIATE THE NEED FOR A LANDCAPE BUFFER. PLANTINGS WOULD BE PROVIDED ON THE WEST OF THE EXISTING DRIVEWAY TO SCREEN THE HOUSES IN THE PROPOSED DEVELOPMENT FROM THE ADJACENT PROPERTIES.

GRAPHIC SCALE

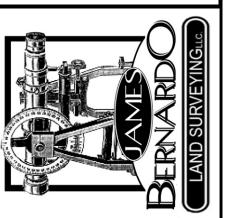

ENTS	HESE DRM- SEON, ATED ANY I THE THE	NGS PERTY	
VOTICE: THESE DOCUMENTS	ARE PROTECTED UNDER A COPYRIGHT © 2023. THESE DRAWINGS OR ANY INFORMATION CONTAINED HEREON, SHALL NOT BE DUPLICATED IN PART OR WHOLE FOR ANY OTHER PROJECT, LOCATION, SITE OR OWNER, WITHOUT THE WRITTEN PERMISSION OF THE COPYRIGHT OF THE COPYRIGH	SURVETOR. INESE DRAMINOS SHALL REMAIN THE PROPERTY OF THE SURVEYOR.	
TESE I	CCTED OR AN VITAINE I BE [WHOL DJECT, NER, V	INESE AIN THI IRVEYO	
Ę:	PROTE RIGHT MINGS N CON L NO ART OR OR OW TEN PE	SURVETOR. INESE D SHALL REMAIN THE I OF THE SURVEYOR	
LON	ARE COPY DRAV ATIO SHAL IN PA OTHE SITE	SHAL OF T	
В	HOUSE SIGN ADDED	1–3–2023	
Α	TEST HOLES, DRAINAGE WATER NOTES AND E&S ADDED	12-3-2023	
LTR	DESCRIPTION	DATE	
REVISIONS			

9


Sheet No.


SHEET 4 OF 8

1" =40'

SEPTEMBER 25, 2023

SUGGESTED PLANT LIST FOR CONNECTICUT RAIN GARDENS

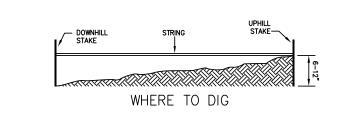

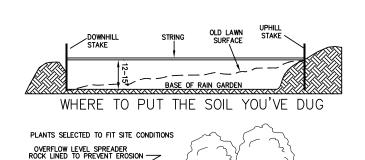



CROSS SECTION OF RAIN GARDEN

PERENNIALS
A. SWAMP MILKWEED (ASLEPIAS INCARNATA) B. NEW YORK ASTER (ASTER NOVAE-BELGIÍ ASTILBE (ASTILBE SPP.) TICKSEED SUNFLOWER (BIDENS ARISTOSA) . JOE PYE WEED (EUPATORIUM FISTULOSUM)

F. ROSE MALLOW (HIBISCUS MOSCHEUTOS) G. IRIS (IRIS VERSICOLOR) H. CARDINAL FLOWER (LÓBELIA CARDINALIS) I SPIKED GAY FEATHER (LIATRIS SPICATA) J. SENSITIVE FERN (ONOCLEA SENSIBILIS)

ROYAL FERN *(OSMUNDA REGALIS)* M. MARSH FERN (THELYPTERIS PALÚSTRIS) N. SPIDERWORT (TRADESCANTIA VIRGINIANA) O. BLACK-EYED SUSAN (RUDHECKIA BIRTA)

GRASSES
P. CREEPING BENTGRASS (AGROSTIS STOLONITERAL) S. TUSSOCK SEDGE (CAREX STRICTA)
U. SWITCH GRASS (PANICUM VIRGATUM) Q. MEADOW FOXTAIL (ALOPECURUS PRATENSIS) T. TUFTED HAIR GRASS (DESCHAMPSIA CAESPITOSA) V. RIBBON GRASS (PHALARIS ARUNDINACEA) R. BLUE JOINT (CALAMOGROSTIS CANADENSIS)

SHRUBS
1. RED CHOKEBERRY (ARONIA ARBUTIFOLIA) BUTTONBUSH (CEPHALANTHUS OCCIDENTALIS) SUMMERSWEET CLETHRA (CLETHRA ALNIFOLIÁ) . SILKY DOGWOOD (CORNUS AMOMUM) 5. GRAY DOGWOOD (CORNUS RACEMOSUM) RED OSIER DOGWWOD (CORNUS SERICEA) 8. WINTERBERRY (ILEX VERTICILLATA)

10. PINXTERBLOOM AZALEA (RHODODENDRON PERICLYMENOIDES) 11. SWAMP AZALEA (RHODODENDRON VISCOSUM) 17. NANNYBERRY (VIBURNUM LENTAGO) 12. ELDERBERRY (SAMBUCUS CANADENSIS) 18. BLACK HAW (VIBURNUM PRUNIFOLIUM) 13. LOWBUSH BLUEBERRY (VACCINIUM ANGUSTIFOLIUM)

9. SPICEBUSH (LINDERA AESTIVALE BENZOIN) 14. HIGHBUSH BLUEBERRY (VACCINIUM CORYMBOSUM) 15. WITHEROD (VIBURNUM CASSINOIDES) 19. AMERICAN CRANBERRY (VIBURNUM TRILOBUM)

ONE OR MORE TREES CAN BE ADDED TO A RAIN GARDEN, DEPENDING UPON IT SIZE. CAUTION SHOULD BE USED THOUGH, AS A TREE CAN QUICKLY TAKE OVER THE GARDEN AND CREATE A DIFFERANT LOOK. REMEMBER, MOST TREES WILL GROW VERY LARGE UNLESS THEY ARE PURPOSELY KEPT SMALL. IF A TREE IS DESIRED, THE FOLLOWING TYPES ARE RECOMMENDED:


TREES
20. RIVER BIRCH (BETULA NEGRA) 21. RED MAPLE (ACER RUBRUM) 22. SWEETGUM (LIQUIDAMBAR STYRACIFLUA)

23. SWAMP WHITE OAK (QUERCUS BICOLOR) 24. PIN OAK (QUERCUS PALUSTRIS) 25. LARCH (LARIX LARICINA)

26. COTTONWOOD (POPULOS DELTOIDES) 27. SHADBLOW (AMELANCHIER SPP.) 28. GREEN ASH (FRAXINUS PENNSYLVANICA)

1. ADDITIONAL PLANTS MAY BE SUBSTITUTED FOR THOSE LISTED ABOVE WITH MUNICIPAL APPROVAL. 2. CALL BEFORE YOU DIG 1-800-922-4455.

THE RAINGARDEN IS SIZED TO ACCOMODATE THE FIRST 1" OF RAINFALL FROM THE ASSOCIATED ROOF AREA. A MINMUM OF 75 SQ FT IS REQUIRED BASED ON A MINIMUM 8" DEPTH.

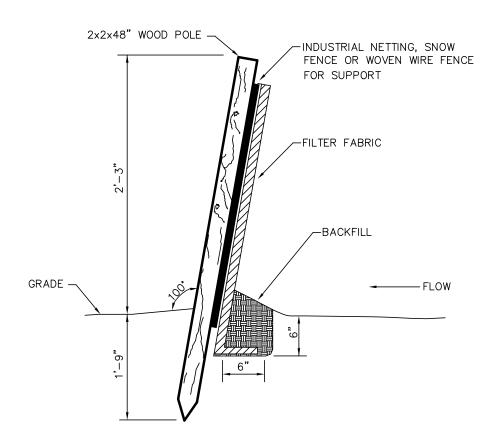

NOTE: PREMANUFACTURED FENCE MAY BE USED.

SEDIMENT FENCE NOT TO SCALE

EROSION & SEDIMENT CONTROL NOTES

- 1. CONSTRUCTION SEQUENCE FOR SOIL EROSION AND SEDIMENT CONTROLS:
- A. INSTALL ALL TEMPORARY CONSTRUCTION ENTRANCES, SEDIMENT FENCES AND/OR HAY BALE BARRIERS AS SHOWN ON THIS PLAN. CONSTRUCTION ENTRANCES SHALL BE INSTALLED AT THE START EACH PROPOSED DRIVEWAY LOCATION.
- B. CLEAR TREES, SHRUBS AND BRUSH IN AREAS WHERE GRADING WILL BE REQUIRED AND GRUB AREAS TO REMOVE ALL STUMPS, ROOTS, ETC. DISPOSE OF ALL MATERIAL CLEARED AND GRUBBED OFF
- C. REMOVE AND STOCKPILE ALL TOPSOIL ON SITE AND PROVIDE A SEDIMENT FENCE ON THE DOWNSLOPE SIDE. SEED STOCKPILE WITH PERENNIAL RYEGRASS AT A RATE OF 40 POUNDS PER ACRE AND MULCH WITH HAY OR STRAW.
- D. EXCAVATE AND/OR FILL WORK SITE TO SUBGRADE LEVEL. FILL WILL BE PLACED AND COMPACTED
- IN 8 INCH LIFTS AND SHALL BE FREE OF BRUSH, RUBBISH, LOGS, BUILDING DEBRIS, OR ANY OBJECTIONABLE MATERIAL. MOISTEN SOIL SURFACE PERIODICALLY WITH WATER TO MINIMIZE DUST. E. CONSTRUCT BUILDINGS AND INSTALL UTILITIES. ADD EROSION CONTROL DEVICES AS NEEDED.


F. PLACE AND COMPACT BASE MATERIAL TO FINAL GRADE. INSTALL PAVED DRIVEWAY WHERE


- G. ALL DISTURBED AREAS SHALL BE GRADED AND STABILIZED AS FOLLOWS:
- 1. PLACE MINIMUM 4 INCHES OF TOPSOIL IN ALL AREAS. APPLY LIMESTONE AND FERTILIZER IN ACCORDANCE WITH SOIL TEST RECOMMENDATIONS.
- 2. APPLY RECOMMENDED SEED MIXTURE AT RECOMMENDED RATE.
- 3. APPLY STRAW OR HAY MULCH ON ALL SEEDED AREAS.
- 4. SEEDING SHOULD TAKE PLACE BETWEEN APRIL 1 AND JUNE 15 OR AUGUST 15 AND SEPTEMBER 30. IF OUTSIDE THESE PERIODS, AREAS SHALL BE STABILIZED WITH STRAW OR HAY MULCHING AT A RATE OF 90 POUNDS PER 1000 SQUARE FEET.
- H. ALL GRADED AREAS WITH SLOPES STEEPER THAN 3 HORIZONTAL TO 1 VERTICAL SHALL BE STABILIZED WITH JUTE NETTING.
- I. WHEN ALL GRADED AREAS ARE PERMANENTLY STABILIZED, REMOVE ALL EROSION AND SEDIMENT CONTROLS. REMOVE TRAPPED SEDIMENT.
- J. IT SHALL BE THE RESPONSIBILITY OF THE APPLICANT TO ENSURE PROPER IMPLEMENTATION OF THE SOIL EROSION AND SEDIMENT CONTROLS AS SHOWN ON THIS PLAN; AND SHALL INCLUDE BUT NOT BE LIMITED TO, INSTALLATION AND MAINTENANCE OF CONTROL MEASURES, INFORMING ALL PARTIES OF SUCH REQUIREMENTS AND NOTIFICATION OF ANY TRANSFER OF THIS RESPONSIBILITY TO OTHER
- K. RECOMMENDED SEED MIXTURE: FUTURA 2000 BY THE CHAS C. HART CO. CONTAINING THE FOLLOWING VARIETIES OF PERENNIAL RYEGRASSES: FIESTA II, BLAZER II, DASHER II AND EXPRESS. A SEEDING RATE OF 5 - 7 LBS PER 1000 SF IS RECOMMENDED.

- 1. WATER SUPPLY WILL BE FROM THE EXISTING TOWN OF EAST LYME MUNICIPAL WATER SYSTEM.
- 2. THE EXISTING HOUSE IS PRESENTLY SERVED BY THE MUNICIPAL WATER SYSTEM.
- WATER SERVICE REQUIREMENTS:
- A. ALL WATER MAIN AND SERVICE INSTALLATIONS SHALL CONFORM TO THE TOWN OF EAST LYME, DEPARTMENT OF UTILITIES, WATER MAIN AND SERVICE CONSTRUCTION SPECIFICATIONS.
- B. REMOTE BUFFALO-STYLE CURB BOXES ARE REQUIRED.
- C. MINIMUM COVER OVER WATER MAINS AND SERVICES SHALL BE 4'-6' FROM FINISH GRADE.
- D. 1" SERVICE CONNECTIONS ARE REQUIRED FOR EACH LOT. WATER SERVICE CONNECTIONS SHALL CROSS DRIVEWAYS AS NEARLY PERPENDICULAR AS POSSIBLE. SCHEDULE 40 PVC SLEEVES SHALL BE INSTALLED FOR EACH DRIVEWAY CROSSING TO FACILITATE FUTURE REPAIRS.

CONSTRUCTION SEQUENCE FOR PUBLIC IMPROVEMENTS

- 1. THE PUBLIC IMPROVEMENTS FOR THIS PROJECT INCLUDE THE INSTALLATION OF THE LANDSCAPE BUFFER IN ACCORDANCE WITH SECTION 23 OF THE EAST LYME ZONING REGULATIONS.
- 2. TO AVOID DAMAGE TO THE PLANTINGS., IT IS RECOMMENDED THAT THE LANDSCAPE BUFFER NOT BE INSTALLED UNTIL AFTER THE INSTALLATION OF THE INDIVIDUAL WATER SERVICES ARE COMPLETE AND THE EXACT LOCATION OF THE INDIVIDUAL DRIVEWWAYS HAS BEEN DETERMINED. A. INSTALL THE INDIVIDUAL MUNICIPAL WATER SERVICE CONNECTIONS FOR EACH LOT.
- B. DETERMINE THE LOCATION OF THE INDIVIDUAL DRIVEWAY CONNECTIONS AND INSTALL IF POSSIBLE. C. PLANT LANDSCAPE BUFFER IN ACCORDANCE WITH SOUND LANDSCAPE TECHNIQUES. COORDINATE SIZE, LOCATION AND QUNATITY WITH TOWN PLANNING STAFF.

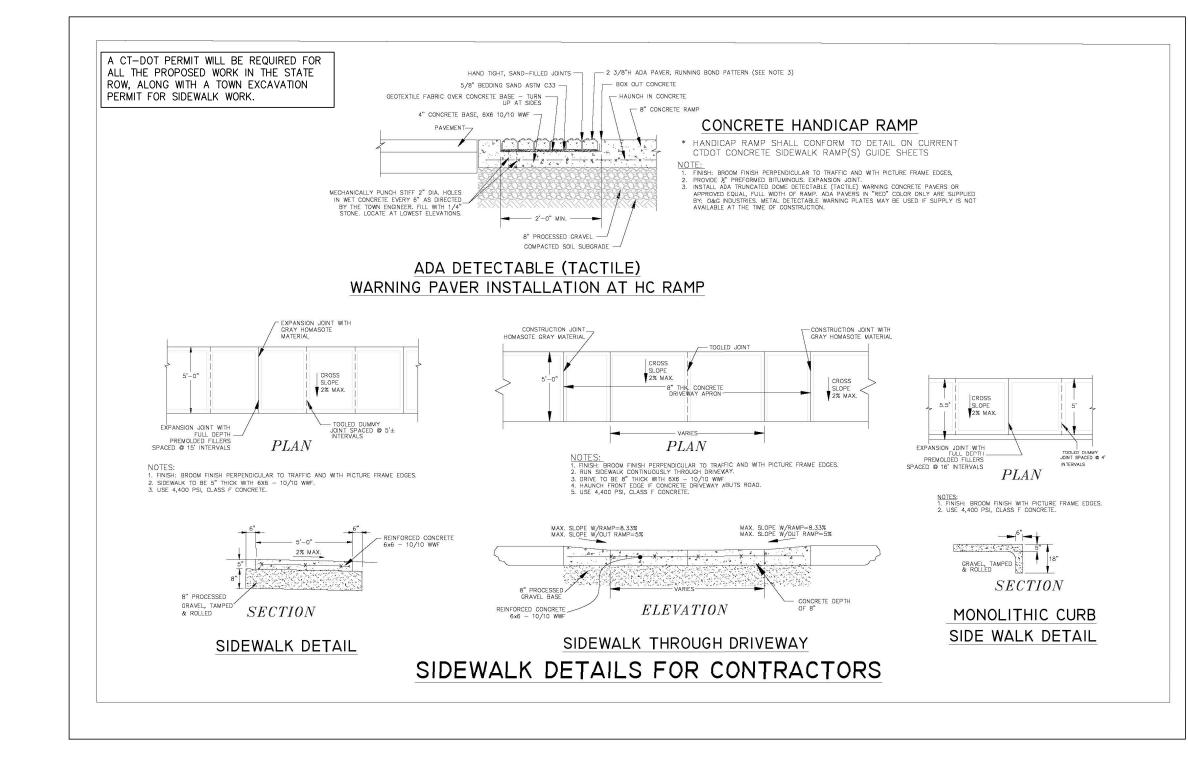

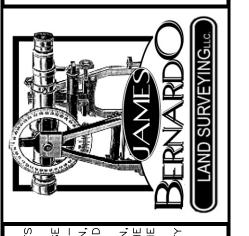

TOWN OF EAST LYME TEST HOLES, DRAINAGE WATER NOTES AND E&S 12-3-2023 DESCRIPTION DATE REVISIONS

9

PENNS' 20


S

Sheet No.

1" =40'

SEPTEMBER 25, 2023 Project No.

SHEET 5 OF 8

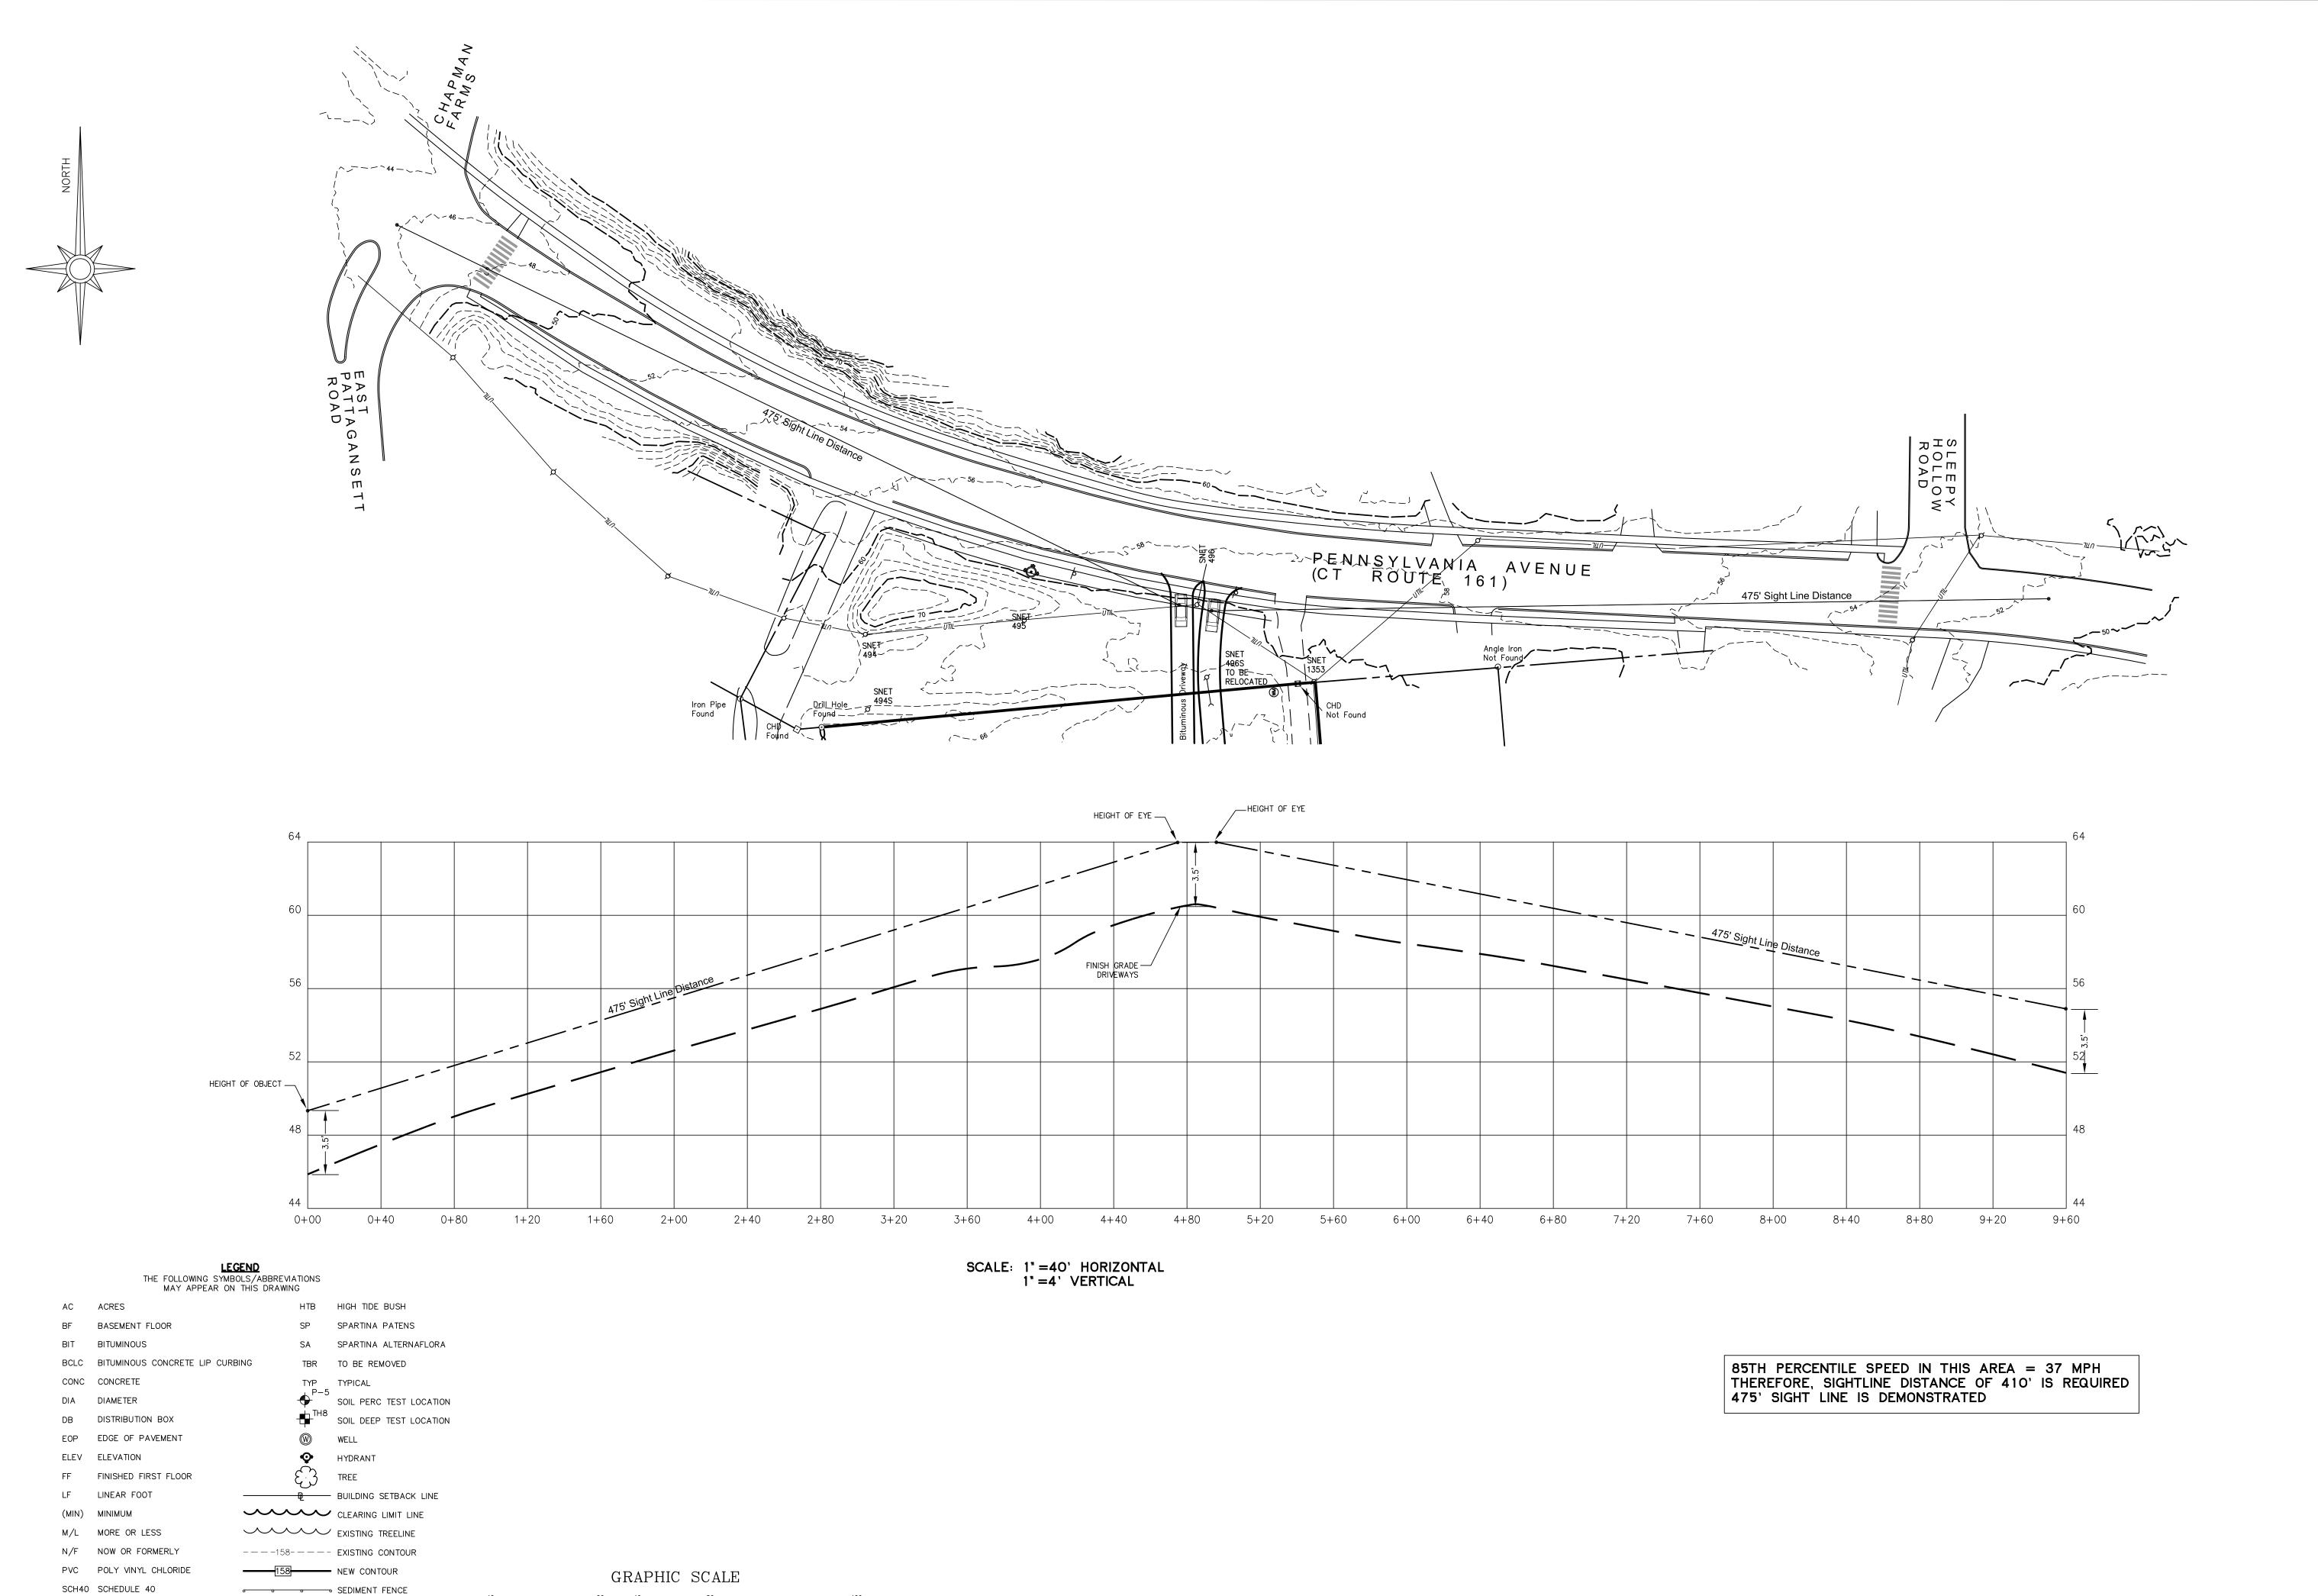

5.4x SPOT ELEVATION

SF SQUARE FEET

TR TO REMAIN

- - - - - STORM DRAIN PIPE

(IN FEET)

1 inch = 40 ft.

STONE WALL

----- W ---- WATER

JAMES BERNARDO
LAND SURVEYING, LLC
102A SPITHEAD ROAD
TERFORD, CONNECTICUT 0
(860) 447-0236
WWW.JBSURVEY.COM



NO REVISIONS TO THIS

TEST HOLES, DRAINAGE WATER NOTES AND E&S 12-3-2023 LTR DESCRIPTION DATE REVISIONS 61


Sheet No.


SHEET 6 OF 8

1" =40'

SEPTEMBER 25, 2023



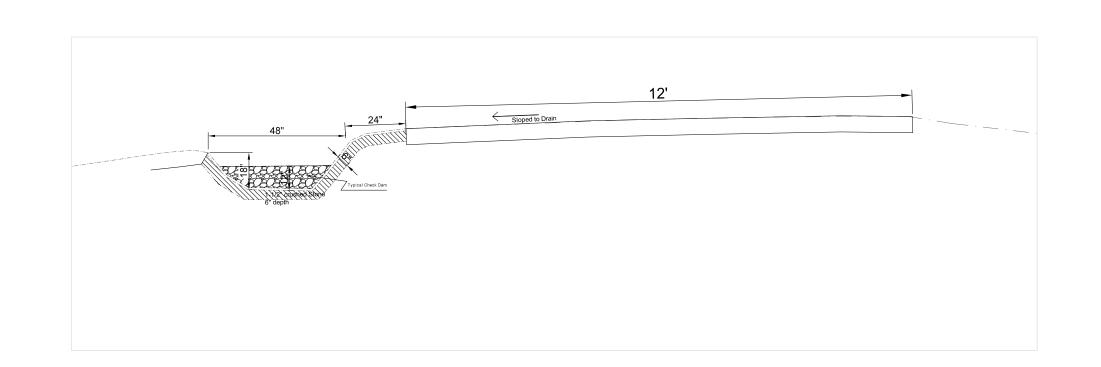

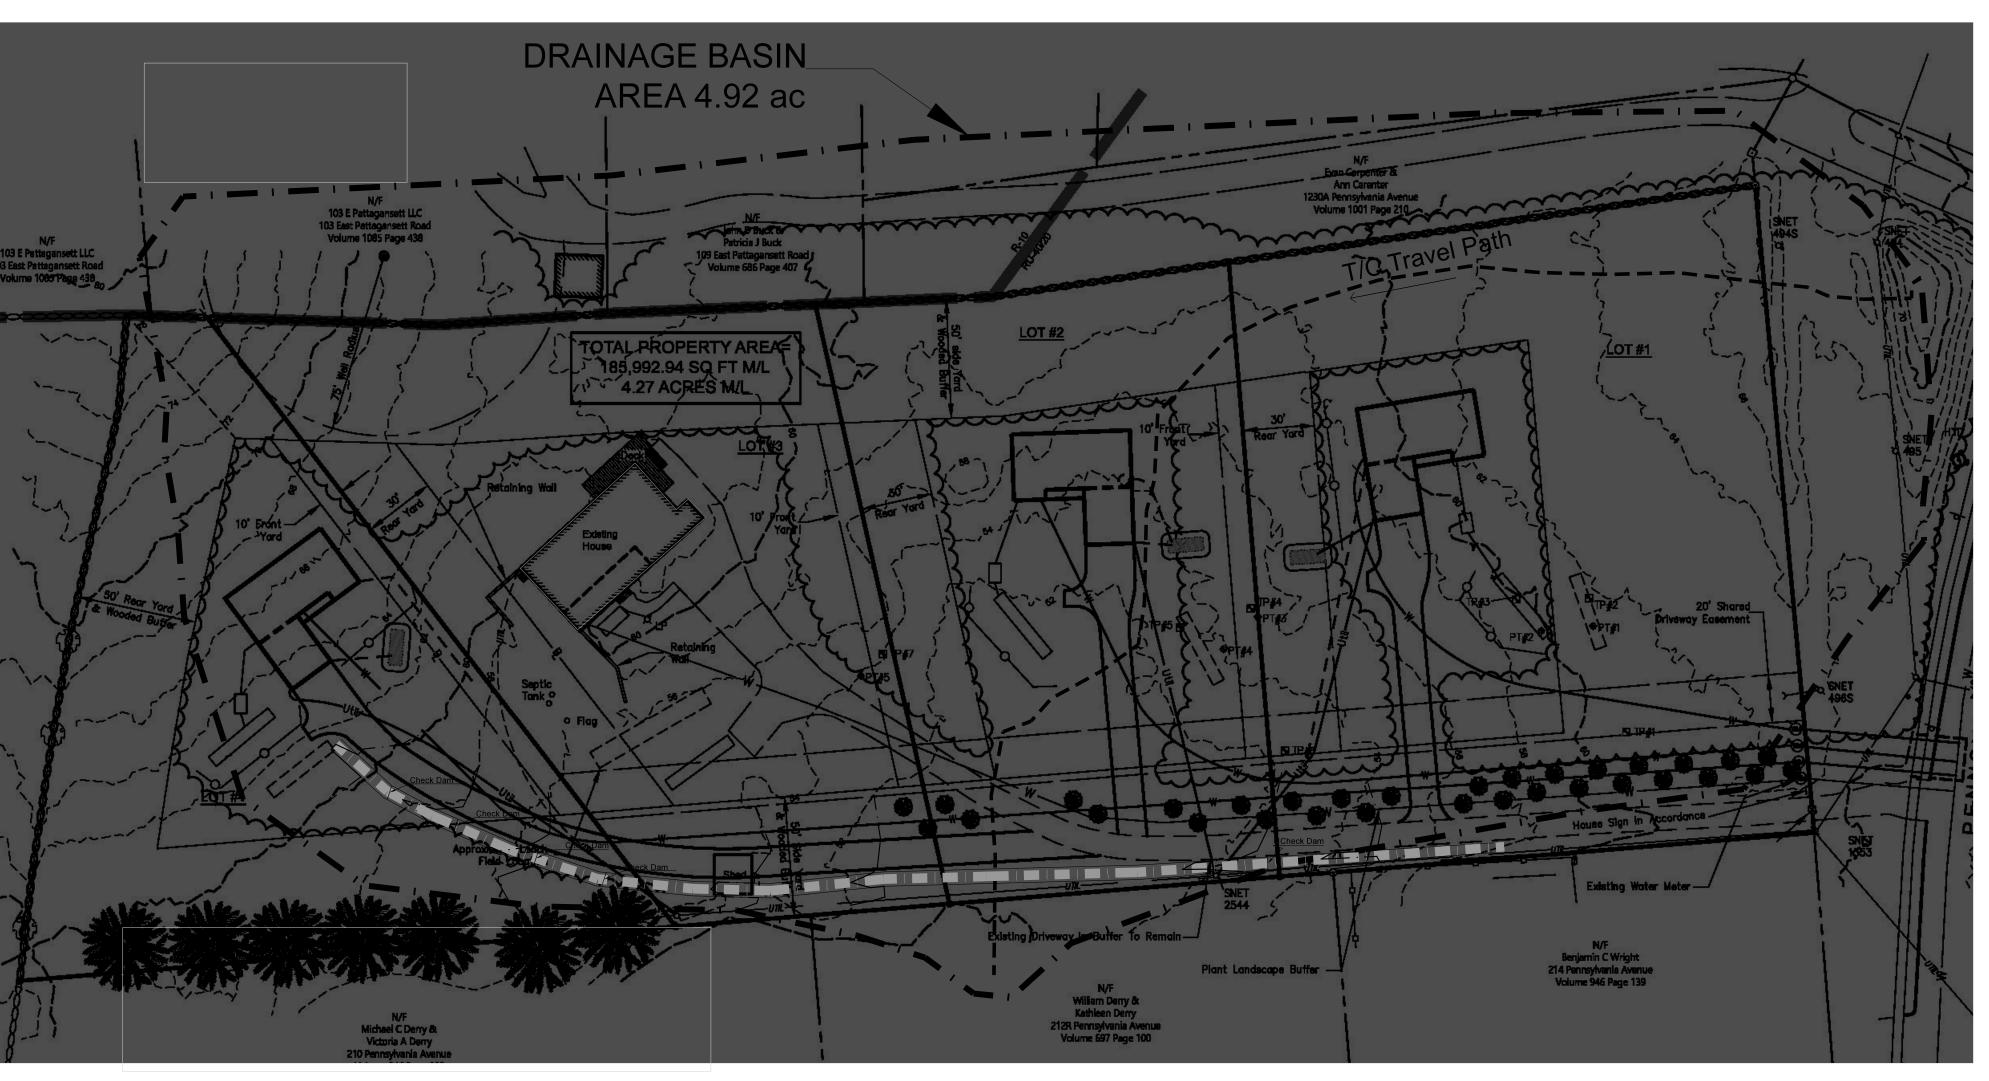

Owner/Applicant: Petrit Marku 57 E. Main Street Mystic CT 06355

May Engineering LLC

Civil Engineering and Site Planning 1297 RT 163 Oakdale, CT 06370 860 884-9671

RE-SUBDIVISION PLAN
STODM/MATED

STORMWATER MANAGEMENT PLAN for property located at 220 Pennsylvania Ave.
EAST LYME, CT

SCALE: 1"=40' DATE: 16 Nov 2023 JOB NUMBER

1-3-2024 NO REVISION TO THIS SHEET

SHEET 7 of 10 231116

