
"138 POST" **ELDERLY HOUSING**

PREPARED FOR 138 BPR LLC 138 BOSTON POST ROAD - MAP 31.1 LOT 7 EAST LYME, CONNECTICUT

DRAWING INDEX:			
TITLE	DWG. NO.	SHEET	NO.
SITE PLAN	SP-1	1 OF	11
GRADING & UTILITY PLAN	UGP-1	2 OF	11
E&S PLAN	ES-1	3 OF	11
E&S NARRATIVE AND CONSTRUCTION DETA	ILS ES-2	4 OF	11
SIGHT LINE PLAN	SL-1	5 OF	11
SU-30 VEHICLE TURNING PLANS	TTP-1	6 OF	11
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CONSTRUCTION DETAILS	CD-3	9 OF	11
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ADS INFILTRATION SYSTEM DETAILS	ADS-1	11 OF	11

ORIGINAL PLAN SET DATED 5/26/2022

NOT FOR CONSTRUCTION FOR REVIEW ONLY

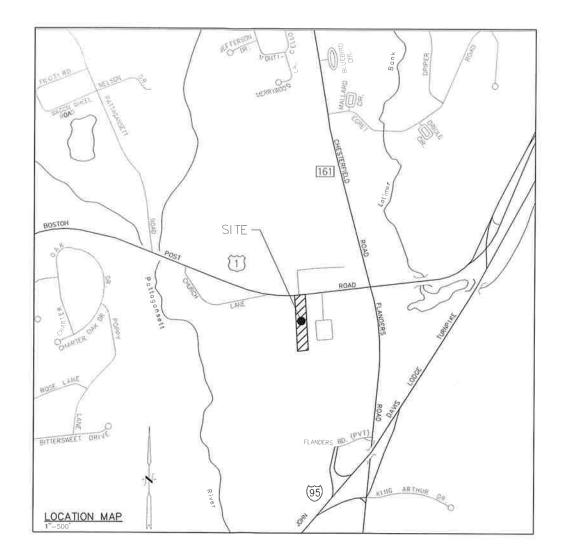

LAND SURVEYOR

GESICK & ASSOCIATES, LLC DONALD GESICK, R.L.S. 19 CEDAR ISLAND AVE. CLINTON, CONNECTICUT 06413

CIVIL ENGINEER



INDIGO LAND DESIGN, LLC JOE WREN, P.E. 40 ELM STREET, 2ND FLOOR OLD SAYBROOK, CONNECTICUT 06475

ARCHITECT

PETER J. SPRINGSTEEL ARCHITECT, LLC 105 STARR STREET MYSTIC, CONNECTICUT 06355


LEGEND EXISTING PROPERTY/STREET LINE BUILDING SETBACK LINE PROPOSED BUILDING ○○○○○○○ FXISTING STONEWALL ---- 70 ---- EXISTING CONTOUR PROPOSED CONTOUR —— SAN —— EXISTING SANITARY LINE ---- ETC---- PROPOSED ELECTRICAL LINE PROPOSED WATER LINE TEST PIT LOCATION EXISTING SANITARY SEWER MANHOLE UTILITY POLE PROPERTY CORNER/DRILL HOLE PROPOSED SPOT GRADE GRADE TO DRAIN PROPOSED AIR CONDENSING UNIT PROPOSED TRANSFORMER PROPOSED ELECTRIC METER PROPOSED GAS METER PROPOSED LIGHTING + + + + PROPOSED LANDSCAPING PROPOSED BUILDING LIGHTING PROPOSED MANHOLE PROPOSED WATER GATE VALVE


Approved	by the East Lyme Zo	ning Commission


PROPERTY OWNER/PROJECT APPLICANT

138 BPR LLC 6 MANSEWOOD ROAD OLD LYME, CONNECTICUT 06371

GENERAL NOTES . SP-1: SITE PLAN SL-1 SKIHT LINE PLAN TTP-1 SU-30 VEHICLE TURNING PLANS ES-1: E&S PLAN ES-2 E&S NARRATIVE AND CONSTRUCTION DETAILS CONSTRUCTION DETAILS CD-3: CONSTRUCTION DETAILS CD-4: CONSTRUCTION DETAILS ADS—1 ADS INFILTRATION SYSTEM DETAILS LANDSCAPE PLANS PREPARED BY TEC LANDSCAPE DESIGN (REFERENCE MAP SITE LIGHTING PLANS PREPARED BY APEX LIGHTING SOLUTIONS (REFERENCE MAP 2,E) ALL MECHANICAL, ELECTRICAL AND PLUMBING DRAWINGS PREPARED BY PROJECT MEP ENGINEER. THIS PLAN WAS COMPILED USING THE FOLLOWING INFORMATION: A CLASS A-2 SURVEY MAP ENTITLE "TOPOGRAPHIC SURVEY OF 138 BOSTON POST ROAD (MAR MOUTE 1), EAST LIME, CONNECTIOUT, PREPARED FOR 138 BPR LLC.", SCALE; 1"=20", DATED, MAY 13, 2021, PREPARED BY GESIGK & ASSOCIATES, P.C. A CLASS A-2 SURVEY MAP ENTITLED "TOPOGRAPHIC SURVEY OF 144 BOSTON POST ROAD (AKA ROUTE 1), EAST LYME, CONNECTICUT, PREPARED FOR ART LIMARES", SCALE: 1"=20", DATED OCTOBER 16, 2019 WITH REVISIONS THROUGH JANUARY 26, 2020, PREPARED BY GESICK & ASSOCIATES, P.C. LANDSCAPING PLANS ENTITLED "138 BPR, EAST LYME, CONNECTICUT, LANDSCAPE PLAN LP-1", SCALE: 1"=20", DATED MAY 12, 2022, PREPARED BY TEC LANDSCAPE DESIGN, INC. LANDSCAPE DESIGN, INC. SITE LIGHTING PLANS ENTITLED "SITE LIGHTING PHOTOMETRIC CALCULATION" SCALE: " = 20", DATED MAY 20, 2022, PREPARED BY APEX LIGHTING SOLUTIONS, SANITARY SEWER ASSULTS ENTITLED "TOWN OF EAST LYME, CONN, E. PATTACAMSET/FLANGERS INTERCEPTOR SMATTARY SEWER SYSTEM CONTINUED, to - BOSTON POST ROMD STA 0400 TO 8.463 (SHEET 19 07 36), AND STA, 8-481 TO STALLI-HO (SHEET 20 07 30), SCALET: " = 40", HORALY 1"=4", VERT.), DATED, NO DATE, PREPARED BY CONSULTING ENMONMENTAL ENGINEERS, INC.

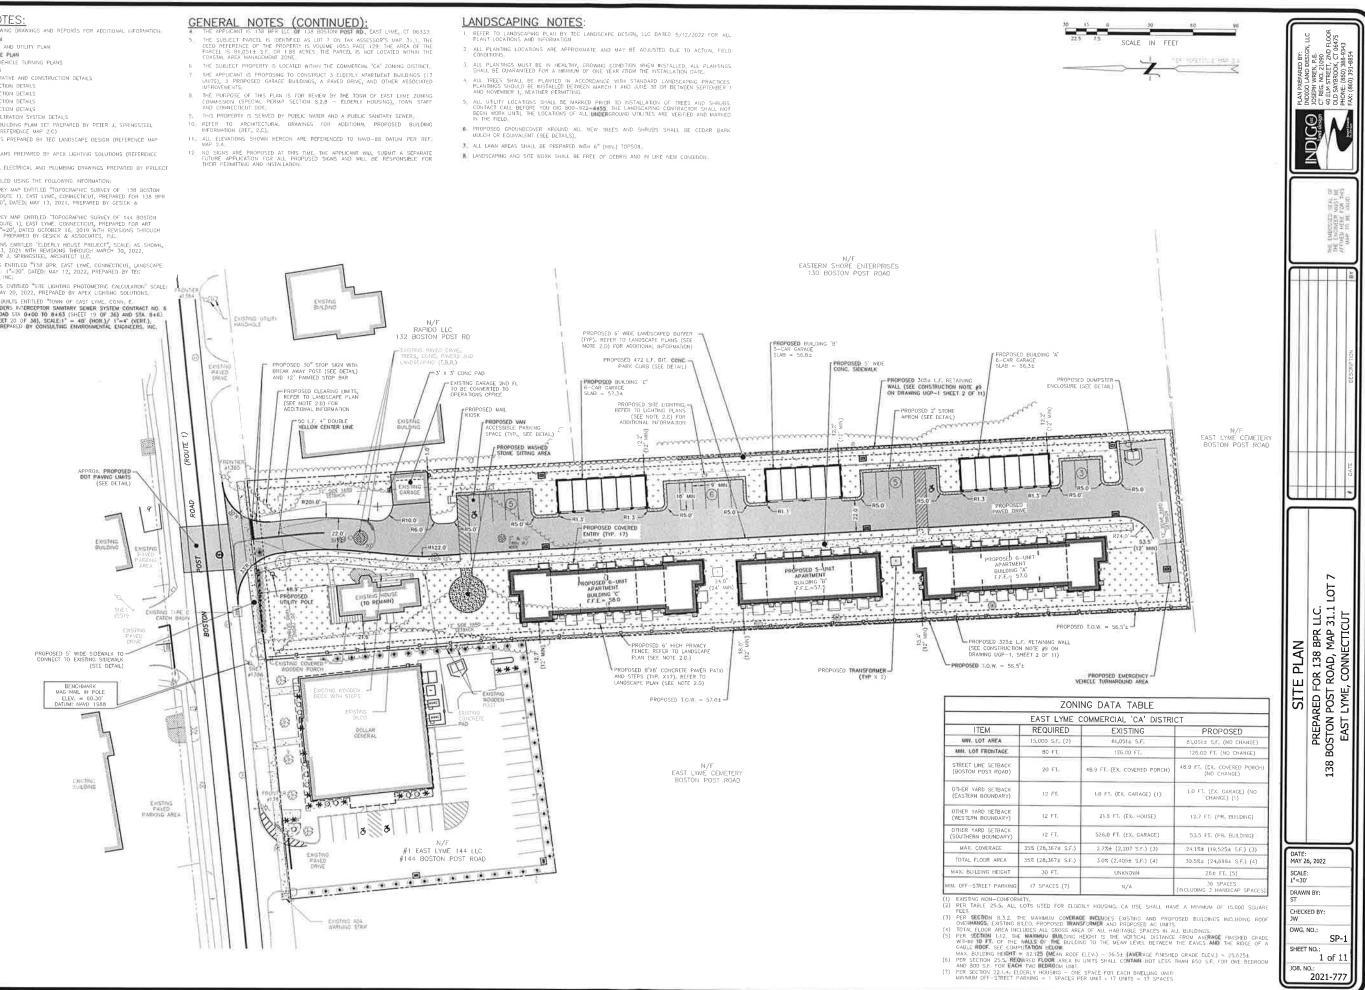

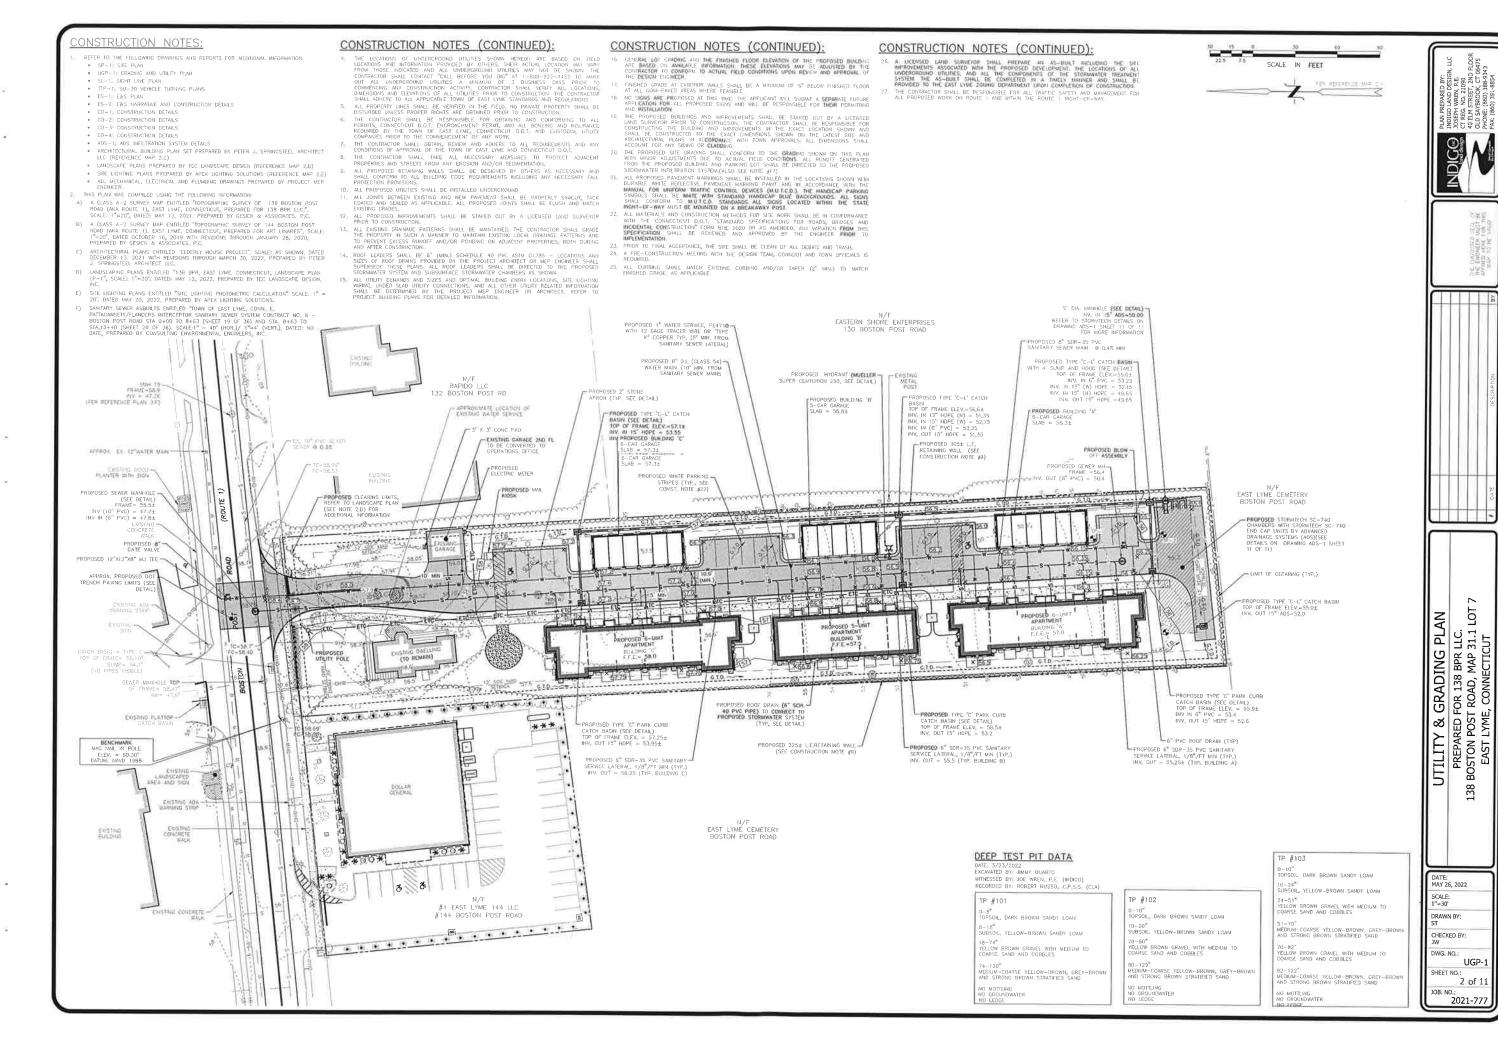

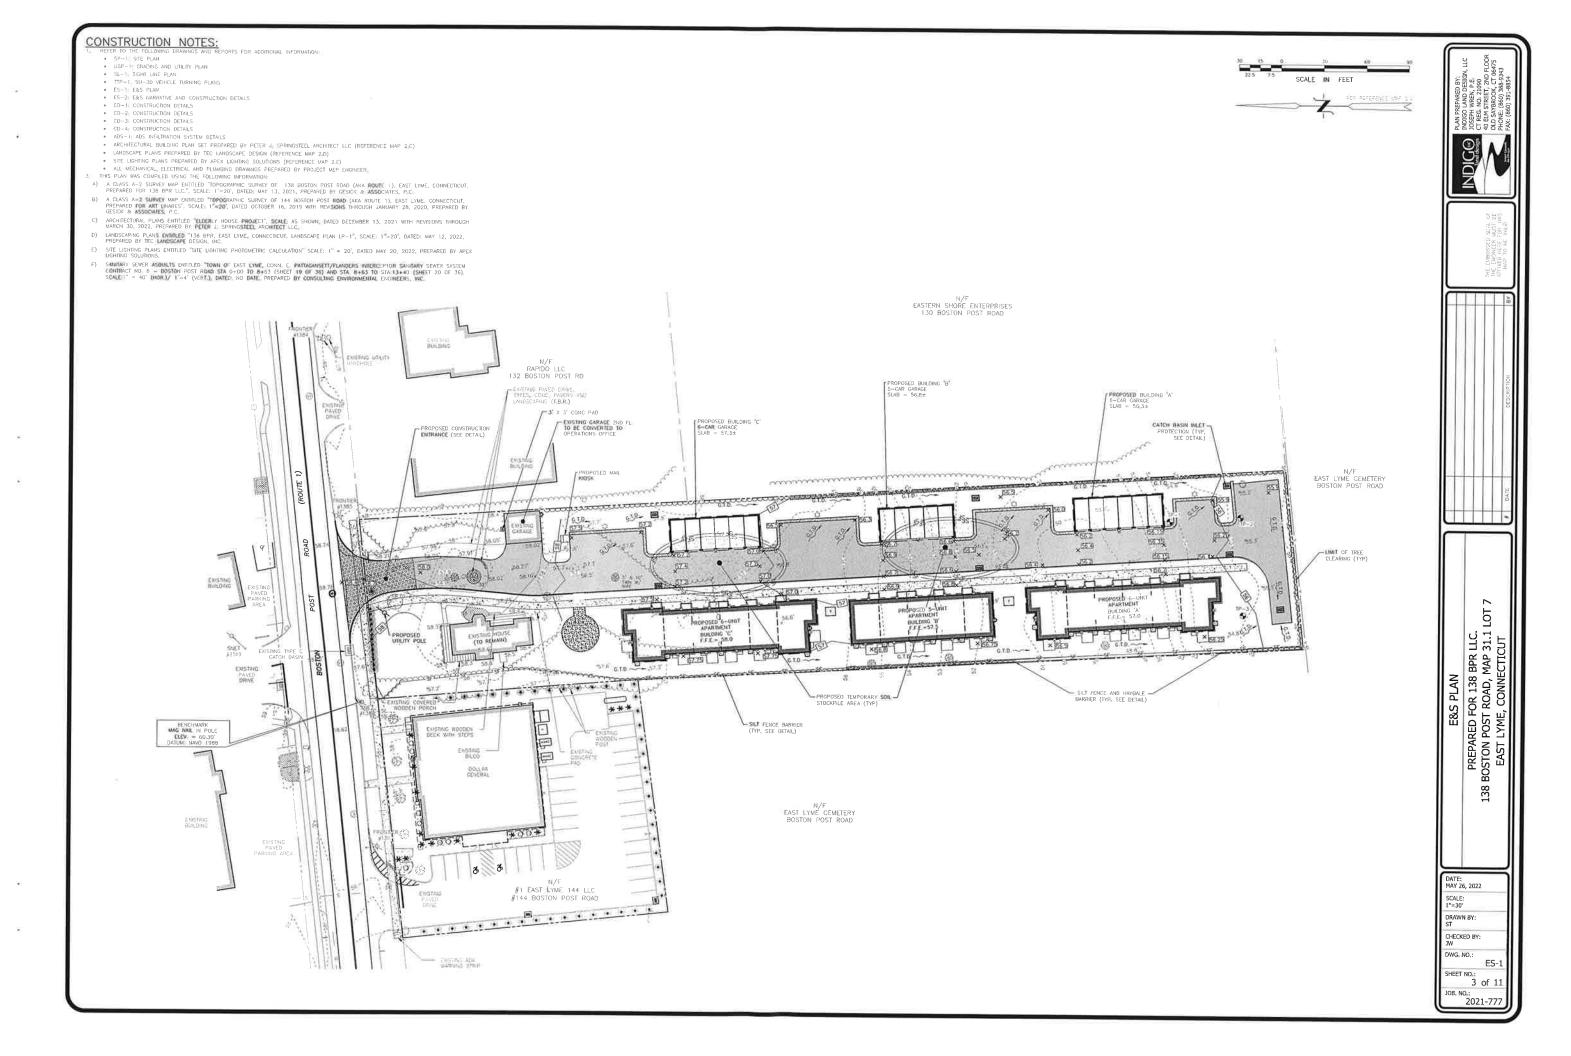

SOIL EROSION & SEDIMENTATION CONTROL PLAN NARRATIVE

THE SITE CONTRACTOR MUST FOLLOW ALL GUIDELINES SET FORTH IN THE MANUAL ENTITLED "2002 CONNECTICUT GUIDELINES FOR SOIL EROSION AND SEDMENT CONTROL" POURSHED BY THE CONNECTICUT COUNCIL ON SOIL AND WATER CONSERVATION IN COOPERATION WITH THE CONNECTICUT DEPARTMENT OF ENVIRONMENTAL PROTECTION, THIS MANUAL IS ALSO KNOWN AS DEEP BUALLING 34

PROJECT DESCRIPTION

APPLICANT IS PROPOSING TO CONSTRUCT 3 ELDERLY BUILDINGS, 3 PROPOSED GARAGES, A PAVED DRIVE AND OTHER ASSOCIATED IMPROVEMENTS. CONSTRUCTION IS ANTICIPATED TO COMMENCE AS SOON AS POSSIBLE ALL EMOSION AND SEDIMENT CONTROLS SHALL BE INSTALLED PRIOR TO CONSTRUCTION ACTIVITIES. E. A. S. CONTROLS SHALL BE MAINTAINED AND REPARED ON REPLACED AS NIZEDED INSOURDOUT THE CONSTRUCTION DURATION, ALL E M.S. CONTROLS SHALL BE REPORTED AND PROPERTY HOSPOSED OF AS SOOM AS THE STEE IS COMPLETELY STRUCTURE.

CONSTRUCTION SEQUENCE

- CONTROL CALL BEFORE YOU DIG TO MARK OUT ALL UTILITY LOCATIONS PRIOR TO ANY CONSTRUCTION ACTIVITIES

 LOSURE ALL LAND USE PERMITS HAVE BEEN SECURED, OBTAIN ALL NECESSARY PERMITS.

 LAND SURVEYOR TO STAKE OUT CLEARING LIMITS AND PROPOSED IMPROVEMENTS.

 LAND SURVEYOR TO STAKE OUT CLEARING LIMITS AND PROPOSED IMPROVEMENTS.

 ENDING HELL HIEFES, BEUREH AND STUDIES HOLD FONESTIME OF CONSTRUCTION ENTRANCE.

 STRIP AND STOCKPILE TOPSOL AND OTHER EXCAVATED SOILS IN AREA(S) SHOWN ON PLAN APPLY TEMPORARY SEED MIXTURE TO PILES IF THEY WILL NOT BE DISTRIBUTED OF MORE THAN 30 DAYS.

 CONSTRUCT RETAINING WALLS AND STORMWATER INFLITATION SYSTEM.

 ROUCH ORADE DRIVEWAY AND PARKING AREAS.

 TO, FRAME AND CONSTRUCT THE PROPOSED BUILDING.

 IN ISTALL BASINS AND ALL UTILITIES.

 IN ISTALL BASINS AND SEED AND MUCH ALL OTHER DISTURBED AREAS AS REQUIRED.

 IN HISTORIC AND SEED AND MUCH ALL OTHER DISTURBED AREAS AS REQUIRED.

 IN HISTALL BASINS AND SEED AND MUCH ALL OTHER DISTURBED AREAS AS REQUIRED.

 IN HISTALL BASINS AND BLUE ALL LANDSCARPEN AND LOUGHT STATEMENT AND STRIPE PAREINER AND LOW STRIPE PAREINER AND LOW STRIPE PAREINER AND LOW STRIPE PAREINER AND STRIPE PAREINER AND LOW STRIPE PAREINER AND LOW STRIPE PAREINER AND STRIPE

LAND DISTURBANCE

ALL EXISTING VEGETATION OUTSIDE OF THE CLEARING LIMITS SHALL BE PROTECTED. EXISTING VEGETATION SHALL BE REMOVED ONLY IN AREAS NECESSARY FOR SITE CONSTRUCTION ACTIVITIES, ANY ADDITIONAL CLEARING OUTSIDE OF THE PROPOSED CLEARING LIMITS SHALL BE APPROVED BY TOWN STAFF PRIOR TO CLEARING
ALL AREAS SHALL REMAIN UNDISTURBED UNTIL IMMEDIATELY PRIOR TO SITE DEVELOPMENT.
ALL CONSTRUCTION FOURIEVENT, MATERIALS AND STOCKMEDS SHALL NOT BE PLACED OUTSIDE OF THE DISTURBED AREAS.
ALL THESE BRUSH, STURPS, WOOD CHIPS OR OTHER ORGANIC MATTER SHALL BE DISPOSED OF PROPERLY OFF—SITE. WOOD CHIPS MAY BE USED AS A SILITAND BARRIER DURING CONSTRUCTION AND SPREAD AFTER SITE IS STABILIZED. NO ORGANIC MATTER INCLUDING TREES, BRUSH AND STUMPS SHALL BE DURIED ON-SIT

STRIPPING AND SYDCKPILING

ALL STOCKPILES THAT CONSIST OF EMODIBLE MATERIALS SHALL BE LOCATED WITHIN AREAS AS SHOWN ON THE SITE PLAN AND SURROUNDED BY A SILTANDIN BARRIER. ANY STOCAPILE THAT WILL PRIMARY UNDSTURBED FOR A PERIOD LONGER THAN JO DAYS SHALL BE SEEDED WITH A TEMPORARY GRASS SEED MAYTURE TO PREVENTE EXCESSIVE EROSION AND SEGMENTATION.

TRENCH EXCAVATION AND BACKEST

THE CONTRACTOR SHALL PROPERLY MAINTAIN ALL BACKFILLED EXCAVATIONS, ANY DEPRESSIONS DUE TO SETTLING IN THESE AREAS SHALL BE FILLED AND RESEEDED AS NECESSARY.

THE WIDTH OF ALL EXCAVATED THERICHES SHALL BE KEPT AS NARROW AS PRACTICABLE TO ACCOMMODATE THE WORK, ALL MATERIALS EXCAVATED FROM TREMCHES SHALL BE STOCKPILED AND USED, AS THENCH BACKFILL MATERIAL UNLESS IT IS OCTERMINED TO BE UNSUITABLE BY THE ENONGER. EXCESS MATERIALS SHALL BE PROPERLY DISPOSED OF BY THE CONTRACTOR.

SOIL EROSION AND SEDIMENT CONTROLS

ALL ADJACENT PROFERTIES AND RECEIVING WATCHCOURSES AND / OR WETLAND AREAS SHALL BE ADEQUATELY PROTECTED FROM SOIL EROSION AND SEDMENTATION BOTH DURING AND ATTER CONSTRUCTION.

ADDITIONAL EROSION AND SEDMENT CONTROLS MAY BE REQUIRED BY THE TOWN AND SHALL BE INSTALLED AND MAINTAINED BY THE CONTRACTOR. THE CONTRACTOR SHALL BE BE PROVISIBLE FOR THE PROPER INSTALLATION AND MAINTENANCE OF ALL EROSION AND SEDMENT CONTROLS BEFORE, DURRING AND AFTER CONSTRUCTION. THE CONTRACTOR IS ALSO RESPONSIBLE FOR THE PROPER REMOVAL AND DEPOSAL OF ALL TROSION AND SEDMENT CONTROLS ONCE THE SITE IS COMPLETELY STABILIZED.

ALL EROSION AND SEDIMENT CONTROLS SHALL BE INSPECTED WEEKLY AND AFTER ALL RAINFALL EVENTS_E & S CONTROLS SHALL BE REPAIRED OR REPLACED AS NECESSARY WITHIN 24 HOURS THROUGHOUT THE CONSTRUCTION DURATION,

IF NECESSARY, A TEMPORARY FILTER FABRIC SILT BARRIER SHALL BE PLACED BENEATH THE GRATE OF THE PROPOSED CATCH BASIN TO PREVENT ANY SILTATION OF THE DRAINAGE SYSTEM, THE FILTER FABRIC SHALL BE REMOVED IMMEDIATELY AFTER THE SURROUNDING AREAS ARE ADEQUATELY

ALL ACCUMULATED SEDIMENTS AT ALL EROSION AND SEDIMENT CONTROLS SHALL BE PERIODICALLY REMOVED AND SPREAD IN AREAS THAT ARE NOT SUBJECT TO EROSION.

THE CONTRACTOR SHALL EMPLOY BEST MANAGEMENT PRACTICES TO CONTROL STORMWATER DISCHARGES AND TO PREVENT EROSION AND SEDMENTATION AND TO OTHERWISE PREVENT POLLUTION OF WETLANDS OR WATERCOURSES OR PRIVATE PROPERTY. THE CONTRACTOR SHALL IMMEDIATELY HOFORM THE COMM OF ANY PROBLEMS INVOLVING EROSION AND/OR SEDIMENTATION THAT HAVE DEVELOPED IN THE COURSE OF, OR THAT ARE CAUSED BY, THE AUTHORIZED WORK.

THE RESPONSIBLE CONTACT PERSON FOR THE INSTALLATION AND MAINTENANCE OR EROSION AND SEDIMENTATION CONTROLS ON THIS PROJECT WILL BE THE SITE CONTRACTOR AND / OR THE GENERAL CONTRACTOR ONCE THE GENERAL CONTRACTOR IS SELECTED, CONTACT INFORMATION WILL BE PROVUED TO IN THE TOWN.

VEGETATIVE TURF ESTABLISHMENT PROCEDURE

SCARIFY ALL AREAS TO BE TOPSOILED AND SOODED. APPLY A MINIMUM OF 6 INCHES OF TOPSOIL ON ALL AREAS TO BE SODDED, APPLY GRASS SEED, LIME, FERTILIZER AND MULCH ACCORDING TO THE FOLLOWING SCHEDULE (WHERE APPLICABLE): PERMANENT SEED MIXTURE:
CREEPING RED FESCUE

O,55 LBS. PER 1,000 SO, FI.
TALL FESCUE

0,45

10714.

FERTILIZER: 10-10-10 APPLY AT 7.5 LBS PER 1,000 SO FT

LIMESTONE: APPLY AT 150 LBS PER 1,000 SO FT.


UUCHING: SPREAD HAY OR STRAW OVER ALL AREAS AFTER SEEDING USE 1 1/2 TO 2 BALES PER 1,000 SQ. FT. TARGET FOR 100% COVERAGE. ANCHOR BY USING NETTING OR TRACKING AS NECESSARY.


TEMPORARY EROSION CONTROL BLANKETS:
USE TEMPORARY EROSION CONTROL BLANKETS ON ALL SEEDED SLOPES STEEPER THAN 3 (H) TO 1 (V) AND/OR AS DIRECTED BY THE DESIGN
FINISHER PROPERTY.

ENGINEER.

SEEDING DATES IN CONNECTION ARE NORMALLY APRIL 1 THROUGH JUNE 15 AND AUGUST 15 THROUGH OCTOBER I SEED CERMINATION NORMALLY
CANNOT BE EXPECTED FROM NOVEMBER THROUGH FERMUARY IF ADEQUATE SEED CERMINATION IS NOT POSSURE DUE TO TIME OF YEAR
CONSTRAINTS, MULCHING SHALL BE ADEQUATELY PROVIDED TO PROTECT THE SEED FROM MAND AND SURFACE ENGIGN UNTIL THE WEATHER
IMPROVES AND THE SEEDING BECOMES WELL ESTABLISHED.

IT SHALL BE THE RESPONSIBILITY OF THE PROPERTY OWNER TO MAINTAIN THE CATCH BASINS, DRAINAGE PIPES AND THE UNDERGROUND DRAINAGE INFILTRATION SYSTEM TO ENSURE PROPER FUNCTION AND EFFICIENT OPERATION.

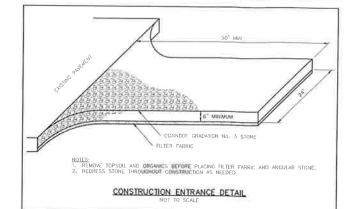

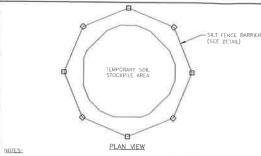


APPLY TEMPORARY SEED MIXTURE TO PILES IF THEY WILL NOT BE DISTURBED FOR MORE 2.


THAN 30 DAYS.

2. ALL SILT FENCE SHALL BE INSPECTED PERIODICALLY AND AFTER ALL RAINFALL EVENTS.

REPAIRS SHALL BE MADE IMMEDIATELY TO KEEP THE SILTATION CONTROL BARRIER EFFECTIVE.


STOCKPILE SILTATION CONTROL DETAIL

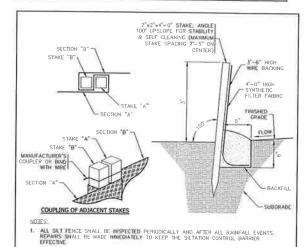

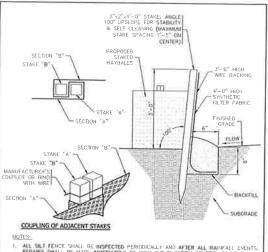

ALL SELT FENCE SHALL BE INSPECTED PERIODICALLY AND AFTER ALL RAINFALL EVENT REPARTS SHALL BE MADE IMMEDIATELY TO KEEP THE SILTATION CONTROL BARRIER FFECTIVE. 2 HAY BALES ANCHORED WITH (2) 2"x2"x3" STAKES FOR EACH BALE.

SILT FENCE/HAYBALE BARRIER

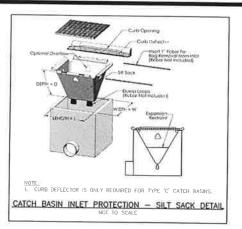

물물등 DETAILS

PLAN PRE INDIGO I JOSEPH V CT REG. 40 ELM S OLD SAY PHONE: (

INDIGO


J. NARRATIVE AND CONSTRUCTION DI PREPARED FOR 138 BPR LLC. 38 BOSTON POST ROAD, MAP 31.1 LOT 7 EAST LYME, CONNECTICUT 138 PLAN,


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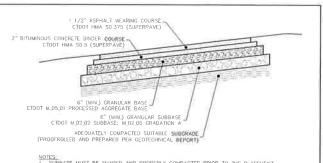
E&S

ES-2 SHEET NO : 4 of 11 JOB. NO.:

2021-777



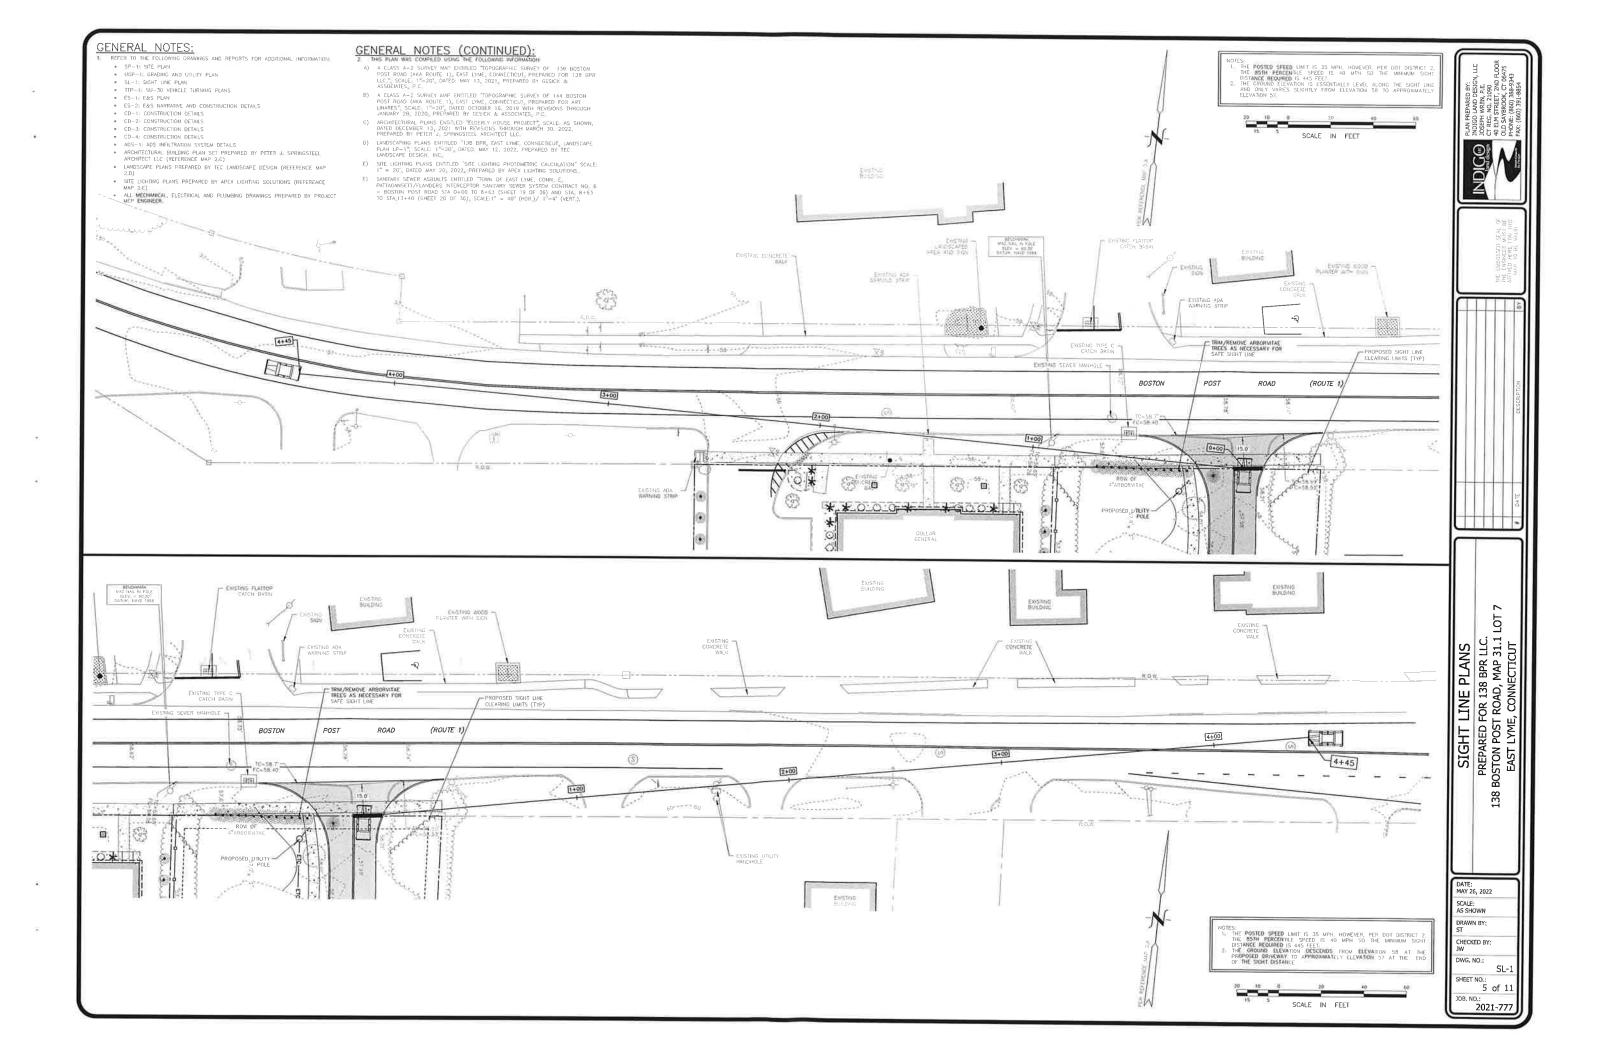

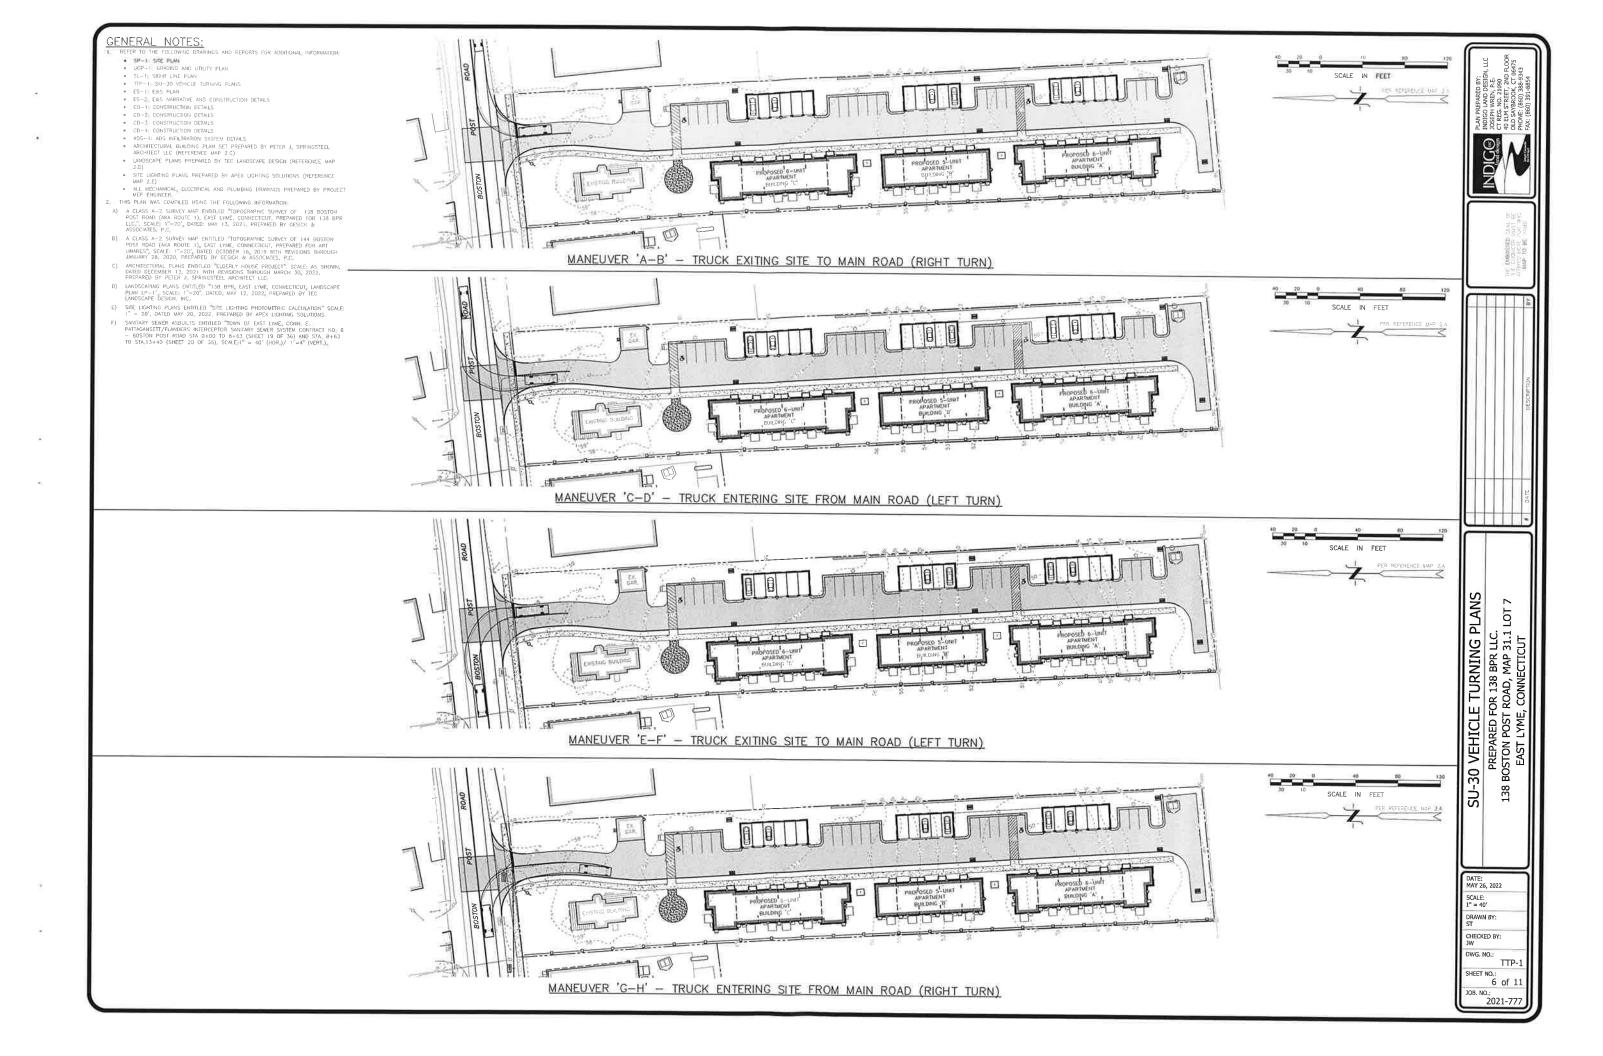

- NOTES:

 1. SUBBASE MUST BE SHAPED AND PROPERLY COMPACTED PRIOR TO THE PLACEMENT OF BASE.

 2. ALL MATERIALS AND CONSTRUCTION METHODOS SHALL CONFORM TO CONNECTICUT D.O.T. STANDARD SPECIFICATIONS.


 3. COMPACTION OF ALL BASE AND SUBBASE MATERIALS SHALL MEET OR EXCEED 95% PROCTOR.

 4. CONTRACTOR SHALL SIE RESPONSIBLE FOR ALL MATERIALS AND COMPACTION TESTING AND SHALL SUBMIT DOCUMENTATION FOR REVIEW.

 5. EXISTING ECCLAYIED MATERIALS MAY DE REJUSED FOR SUBBASE IF MATERIAL IS CONNUOT SPECIFICATIONS.

 6. IF SHALLOW LEDGE IS DEMONITIEDED, CONTRACTOR SHALL CONSULT WITH DESIGN ENGINEER TO MAKE APPROPRIATE ADJUSTMENTS.


TYPICAL PAVEMENT SECTION DETAIL (PARKING AREAS)

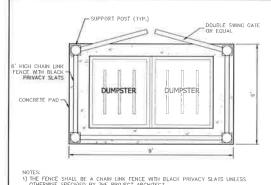



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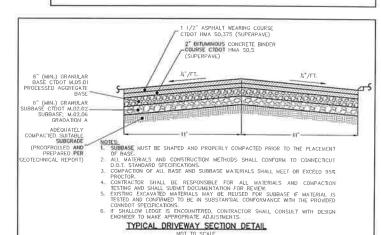
1) THE FENCE SHALL BE A CHAIN LINK FENCE WITH BLACK PRIVACY SLATS UNLESS
OTHERWISE SPECIFIED BY THE PROJECT ARCHITECT.
2) FENDING SHALL NOT EXCEED 6 FEET IN HEIGHT MEASURED FROM FINISHED GRADE.
3) ALL DIMENSIONS ARE INTENDED TO ACCOMMODATE THE PROPOSED DUMPSTERS.


DUMPSTER ENCLOSURE DETAIL




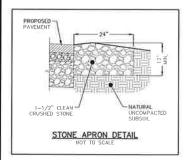

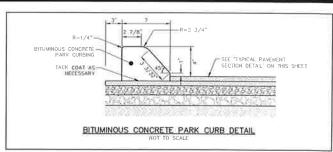

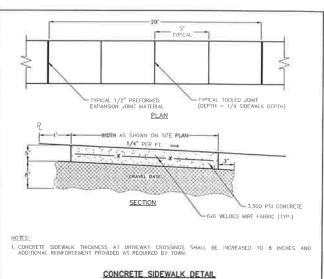


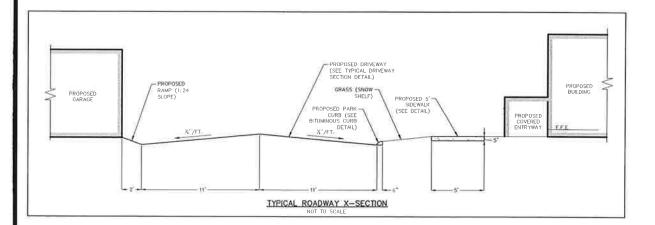

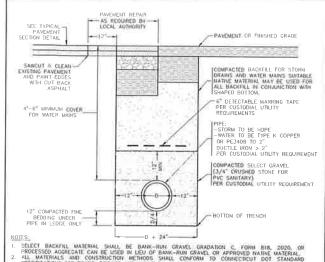


SELECT BACKFILL MATERIAL DIALL BE BAIN-RUN CRAVEL GRADATION C, FORM BIB, 2020, OR PROCESSED AGGREGATIC CAN BE USED BY LIEU OF BAIN-RUN GRAVEL OR APPROVED NATIVE MATERIAL. ALL MATERIALS AND CONSTRUCTION METHODS SHALL CONSIDER TO GONECTICAL OOT STANDARD SPECIECATIONS FOR PROADS, BRIDGES AND INCORPINAL CONSTRUCTION FORM 888, 2020 OR AS AMERICED ALL UTILITIES SHALL BE INSTALLED IN ACCORDANCE WITH ALL TOWN OF EAST LYME AND CUSTODIAL UTILITY COMPANY SPECIFICATIONS.
ALL PROPOSED MATERIALS SHALL BE INSTALLED AS SHOWN OR AS APPROVED BY THE TOWN OF EAST LYME AND/OR CUSTODIAL UTILITY COMPANY.


TYPICAL TRENCH DETAIL

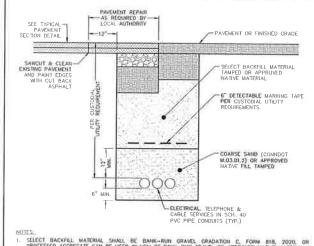

- SELECT BACKFILL MATERIAL SHALL BE BANK-RUN GRAVEL GRADATION C. FORM BIB, 2020. DR PROCESSO AGGREGATE CAN BE USED IN LEU OF BANK-RUN GRAVEL OR AFPROYED NATIVE MATERIAL ALL MATERIALS AND CONSTRUCTION METHODS SHALL CONFIGURE TO CONFECTION TO STANDARD SPECIFICATIONS FOR ROADS, BRIDGES AND INCIDENTAL CONFIRMENTIAN FOR BOADS, BRIDGES AND INCIDENTAL CONFIRMENTIAN FOR BOADS, BRIDGES AND INCIDENTAL CONFIRMENTIAN FOR BOADS, BRIDGES AND INCIDENTAL CONFIRMENTIAN OF EAST LINE AND CUSTOMAL UTILITY COMPANY SPECIFICATIONS.
 ALL PROPOSED MATERIALS SHALL BE INSTALLED AS SHOWN OR AS APPROVED BY THE TOWN OF EAST LYME AND/OR CUSTOMAL UTILITY COMPANY.

TYPICAL UNDERGROUND UTILITY TRENCH CROSS SECTION

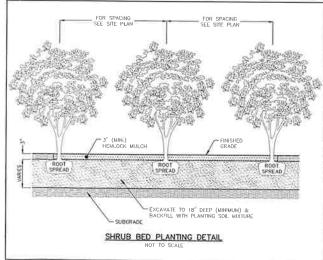

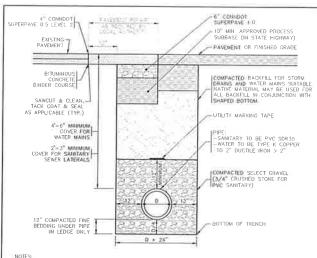

- SELECT HACKFILL MATERIAL, SHALL BE BANK-RUID GRAVEL GRADATION C. TORN BITE 2070, OR PROCESSED AGGREGATE CAN BE USED IN LEU OF BANK-RUID GRAVEL OR APPROVED HATIVE MATERIAL. AND CONSTRUCTION METHODOS SHALL CONFORMED AND CONSTRUCTION OF SECURIATIONS FOR ROADS, BROCKS MID INCORPLAR, CONSTRUCTOR FOR MID 2070 R AS AMERICAL UTILITY COMPANY SECURICATIONS. ALL UTILITY COMPANY SECURICATIONS. ALL UTILITY COMPANY SECURICATIONS. ALL WORK WITHIN THE STRAILED BY AND SECURICATIONS. ALL WORK WITHIN THE STRAILED BY INSTALLED BY AND SECURICATIONS. ALL WORK WITHIN THE STRAILS SHALL BE INSTALLED BY AND SECURICATIONS. ALL PROPOSED MATERIALS SHALL BE INSTALLED BY AS SHOWN OR MATCH EXISTING CONDITION AS APPROVED BY THE TOWN AND/OR D.O.T. INSPECTOR.

 SECURITIES SHALL BE TOWN AND/OR D.O.T. INSPECTOR. TO ALL PROPOSED MATERIALS SHALL BE INSTALLED BY THE TOWN AND/OR D.O.T. INSPECTOR. SHOWN OR MATCH EXISTING CONDITIONS AS APPROVED BY THE TOWN AND/OR D.O.T. INSPECTOR. SHOWN OR MATCH EXISTING CONDITIONS OF RESPONSED CONCRETE PAYMENT IS ENCOUNTERED. THE CONTRACTOR SHALL COORDINATE WITH CONNECTION D.O.T. DISTRICT 2 FOR ANY SPECIAL REQUIREMENTS.

TYPICAL STATE ROADWAY TRENCH DETAIL

-17 GAUGE ADMEALED WIRE W/ RUBBER HOSE (BLACK) 4" HEMLOCK MUL $\frac{\text{NOTE:}}{l_{\theta}}$. MULCH SHALL NOT BE PILED AROUND THE BASE OF THE TREE. TREE PLANTING DETAIL

-5'R (MIN.) PLAN SAWCUT AND TACK COAT-EXISTING PAVEMENT AS NEEDED 6" (MIN.) PROCESSED GRAVEL BASE-ADEQUATELY COMPACTED SUITABLE

BITUMINOUS CONCRETE DRIVEWAY APRON


_ CONSTRUCTION DETAILS
PREPARED FOR 138 BPR LLC.
38 BOSTON POST ROAD, MAP 31.1 LOT 7
EAST LYME, CONNECTICUT 138


PLAN PRA INDIGO JOSEPH CT REG. 40 ELM S OLD SAY PHONE:


DATE: MAY 26, 2022 SCALE: AS SHOWN RAWN BY: CHECKED BY:

DWG. NO.: CD-1 SHEET NO.: 7 of 11


JOB. NO.: 2021-777

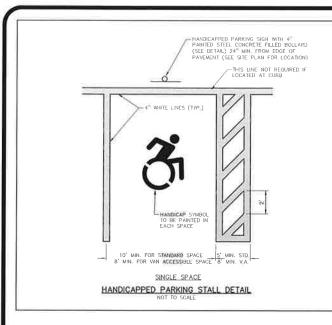

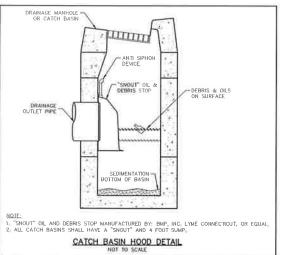

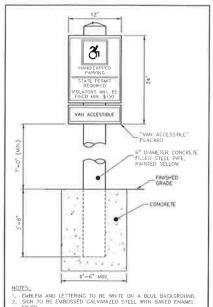


VAN ACCESSIBLE HANDICAPPED PARKING SIGN WITH BOLLARD DETAIL

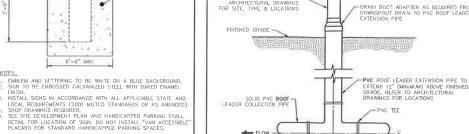


SUNPARK BLECKROMICS CORP.

DOWNSPOUT CONNECTION DETAIL & PERIMETER ROOF DRAIN

WALL MOUNTED LIGHTING DETAIL

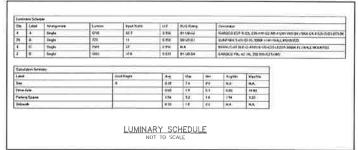


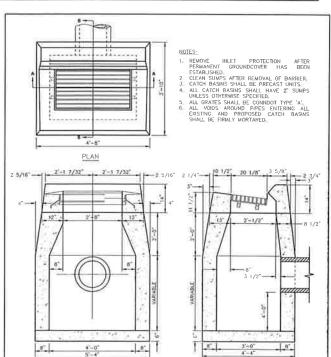


TYPE "C" PARK CURB CATCH BASIN DETAIL

SECTION B-B

SECTION A-A

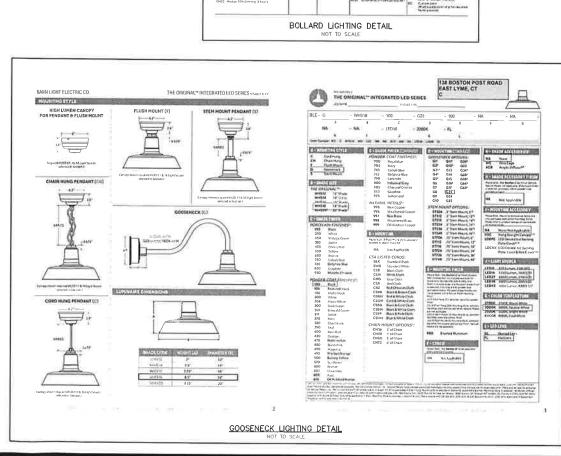

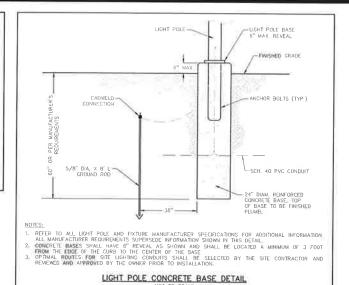

EPARED D LAND D WREN, NO 210 STREET, BROOK,

225

CONSTRUCTION DETAILS
PREPARED FOR 138 BPR LLC.
88 BOSTON POST ROAD, MAP 31.1 LOT 7
EAST LYME, CONNECTICUT

138

DATE: MAY 26, 2022

SCALE: AS SHOWN

DRAWN BY: CHECKED BY:

DWG, NO.:


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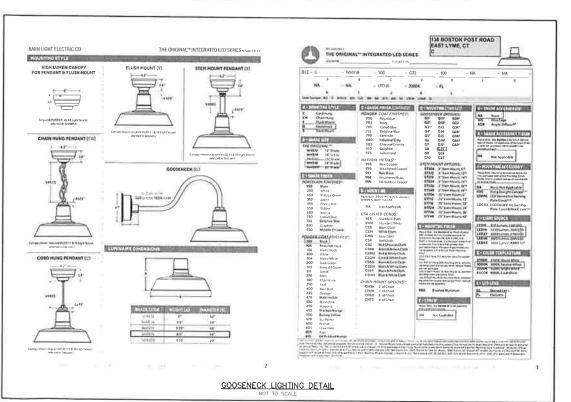
CD-2


8 of 11


ЈОВ. NO.: 2021-777


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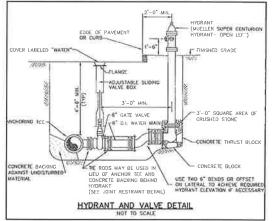





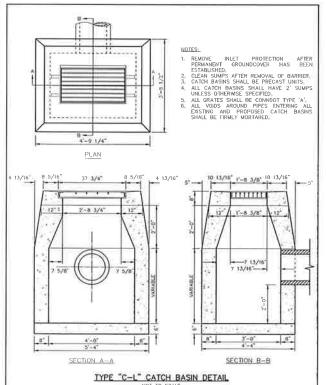


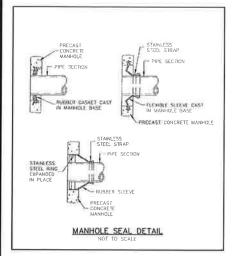


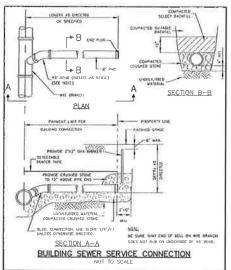

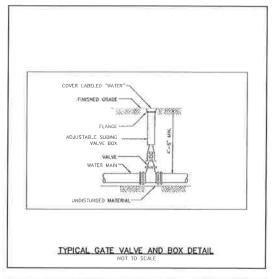

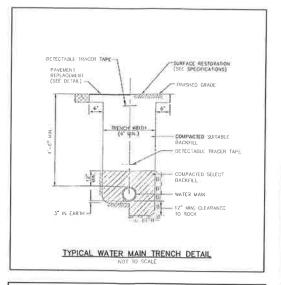

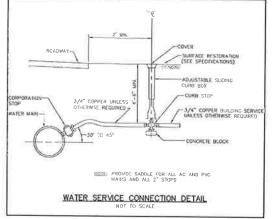

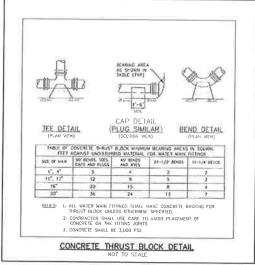


PUSH ON JOHN POE AND/ANNA C151/A 21.11-80 OL CLASS 54-


- 3/4" THREADED RODS W/NUTS AND WASHERS 24" TYPICAL LENGTH

HIM EYE-BOLTS, NUTS & WASHERS

© PUBLICAL JOINT RETERANT USING MCCHANICAL JOINT RETAINER CLANDS AND LACKS () PUSH-ON JOINT RETAINER GLANDS

TYPICAL JOINT RESTRAINT DETAIL

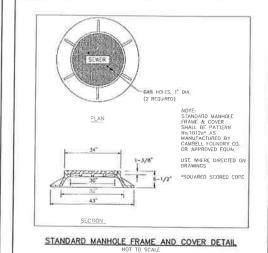

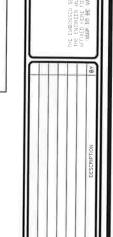

SEWER)

8 BPR LLC. , MAP 31.1 LOT 7

CONSTRUCTION DETAILS (WATER PREPARED FOR 138 BPR LLC. 138 BOSTON POST ROAD, MAP 31.1 LC EAST LYME, CONNECTICUT

MAY 26, 2022

DRAWN BY:

CHECKED BY:

DWG. NO.:

SHEET NO .:

JOB, NO.: 2021-777

CD-3

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250 psig working pressure — 500 psig test pressure

A-421 4-1/2" three-way 2 hose nozzles and 1 pumper nozzle A-423 5-1/4" three-way 2 hose nozzles and 1 pumper nozzle

200 psig working pressure — 400 psig test pressure

A-420	4-1/2"	two-way	2 hose nozzles
A-422	5-1/4"	two-way	2 hose nozzles
A-424	4-1/2"	one-way	l pumper nozzle
A-425	5-1/4"	two-way	2 pumper nozzles

Storz pumper nozzle option —

• Available for 5" pumper nozzles, an integral storz connection allows the fire department to connect its pumper hose to the hydrant with a quick, quarter-turn action.

· No thread alignment, cross threading or leakage problems.

4-way with monitor elbow -

• Monitor style eliminates a possible leak path with separate monitor nozzle attachment.

• All parts interchangeable with Mueller Super Centurion 250 hydrant.

• 250 psi working pressure; 500 psi test pressure.

• Full flow 4-way openings: 4" monitor elbow, one 4-1/2" pumper nozzle, two 2-1/2" hose nozzles.




Size of Hydrant	Aqua-Grip TM System IPS/DIPS	Flanged*	Mech. Joint	D-150 Mech. Joint	Slip-On
4-1/2"	6***	4 6	4".6".8"	4", 6"	6"
5-1/4"	6***	4", 6"	4", 6", 8"	4", 6"	6*


(Auxiliary gate valves with flanged outlet and choice of inlet can be attached to hydrant with flanged inlet.)


*Available with vertical or horizontal inlet.

**Two styles available: IPS (PVC, PE, steel) or DIPS (DI, PVC, PE).

MUELLER CENTURION HYDRANT DETAIL

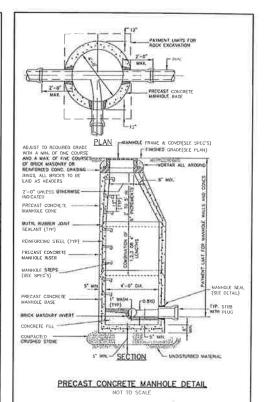

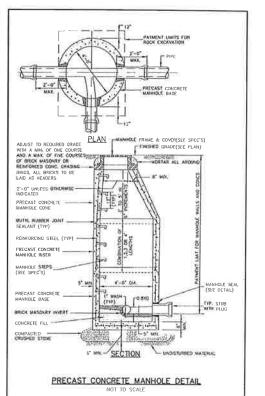


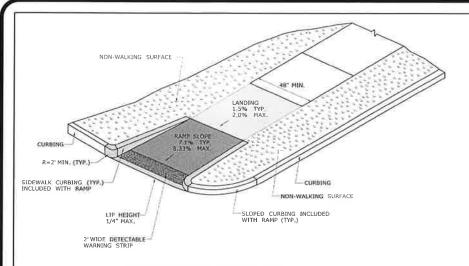


SINGLE DIRECTION - RETURN CURB WITH NON-WALKING SURFACE (TYPE 16)

ADA DETECTABLE WARNING PLATES SHALL BE INCLUDED ON THE SIDEWALK, ON BOTH SIDES OF THE DRIVEWAY CROSSING, THE WARNING PLATES SHALL BE BY NEENAH FOUNDRY, CAST GRAY IRON, WARNING PLATES SHALL BE INSTALLED IN CORPORANCE WITH ALL MANUFACTURER INSTRUCTIONS AND SPECIFICATIONS.

PROPOSCO SIDEWALK ALONG ROAD AND WALKWAYS TO BUILDING SHALL BE CONSTRUCTED TO MEET OR EXCEED AND ACCESSIBILITY REDUREMENTS, ENTIRE SIDEWALK SLOPE SHALL NOT EXCEED 2% GRADE. MIN GRANULAR FILL (CONNODT MOZO)), PORTION OF CONCRETE SIDEWALK HALT TRANSPESS ORIVEWAY SHALL BE B'THICK WITH ADDITIONAL REINFORCEMENT AS REQUIRED BY THE LOCAL AUTHORITY, TOOLED JOINTS (OPPTH = 1/4 SIDEWALK ORPHY) SHALL BE PROVIDED AT 5 FOOT INTERVALS, PREFORMED 1/2" EXPANSION JOINT MATERIAL SHALL BE PROVIDED AT 5 FOOT INTERVALS, PREFORMED 1/2" EXPANSION JOINT MATERIAL SHALL BE PROVIDED AT 5 FOOT INTERVALS, PREFORMED 1/2" EXPANSION JOINT MATERIAL SHALL BE PROVIDED AT 5 FOOT INTERVALS, PREFORMED 1/2" EXPANSION JOINT MATERIAL SHALL BE 16 OF 10, HANDIGAP ACCESSIBLE PARKING DETAIL ON SHEET 7 OF 10 AND SITE PLANS FOR SIDEWALK WIGHTS AND OTHER RELATED INFORMATION.

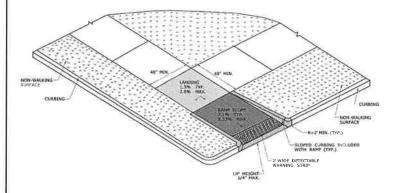


RESTRICTED PEDESTRIAN CROSSING SIDEWALK RAMP WITH NON-WALKING SURFACE (TYPE 20)

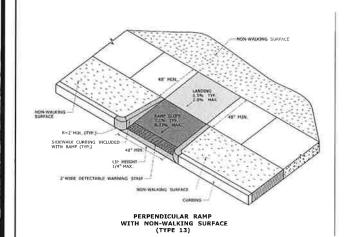


GENERAL NOTES:


- GENERAL NUTES: 1, SIDEWALK RAMPS SHALL HAVE A COARSE BROOM FINISH TRAVERSE TO THE SLOPE OF THE RAMP, 2, VERTICAL SURFACE DISCONTINUITIES AT JOINTS SHALL NOT EXCEED $^{1}_{4}$ INCH.
- 3. REMOVAL OF EXISTING SIDEWALK FOR NEW RAMP INSTALLATIONS SHALL BE TO THE NEAREST EXPANSION OR CONTRACTION JOINT.
- 4 THE RUNNING SLOPE OF THE CURB RAMP SHALL BE 8.3 PERCENT MAXIMUM BUT SHALL NOT REQUIRE THE RAMP LENGTH TO EXCEED 15 FEET.

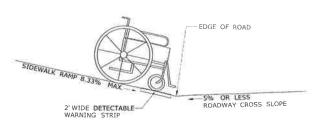


SIDEWALK RAMP GRADE AT ROADWAY CROSS SLOPE OF 5% OR LESS

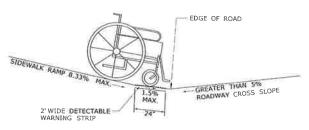


SIDEWALK RAMP GRADE AT ROADWAY CROSS SLOPE OF GREATER THAN 5%

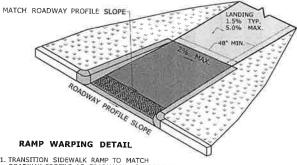

- 1. TRANSITION SIDEWALK RAMP TO MATCH ROADWAY PROFILE AS GRADUALLY AS POSSIBLE, DO NOT EXCEED 3 % PER FOOT CROSS SLOPE RATE OF CHANGE WHEN TRANSITIONING TO ROADWAY PROFILE.
- 2. COMPLETE TRANSITION TO ROADWAY PROFILE BEHIND DETECTABLE WARNING SURFACE.

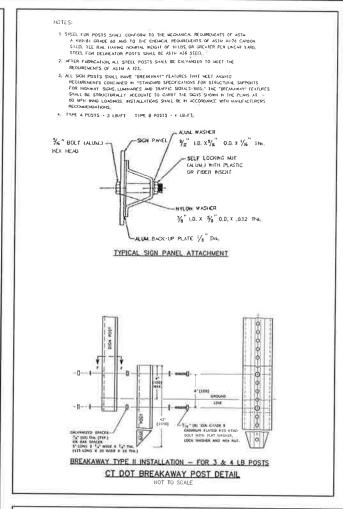

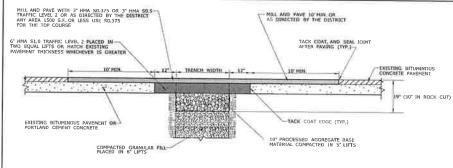

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CONSTRUCTION DETAILS (CT PREPARED FOR 138 BPR LLC. 138 BOSTON POST ROAD, MAP 31.1 LC EAST LYME, CONNECTICUT

DATE: MAY 26, 2022

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CD-4


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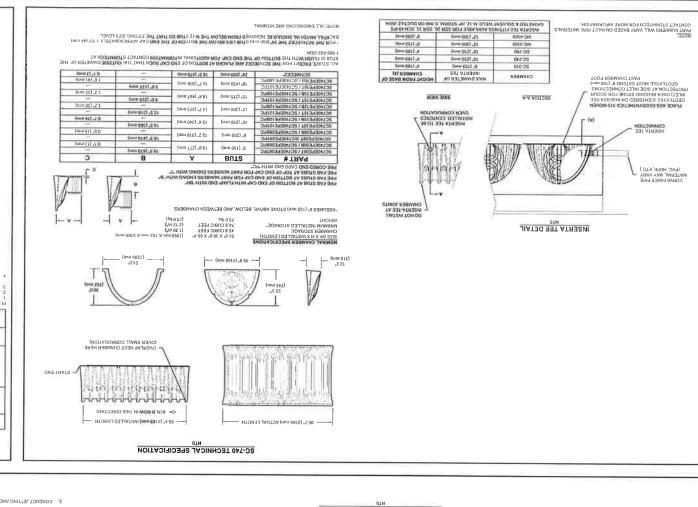
SCALE: 1"=30" DRAWN BY:


PERMANENT PAVEMENT REPAIR WITH MILLING



DOT ENROACHMENT PERMIT - PAVEMENT REPAIR DETAILS

DOT SIDEWALK DETAILS

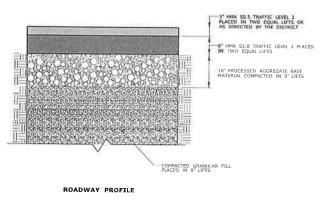

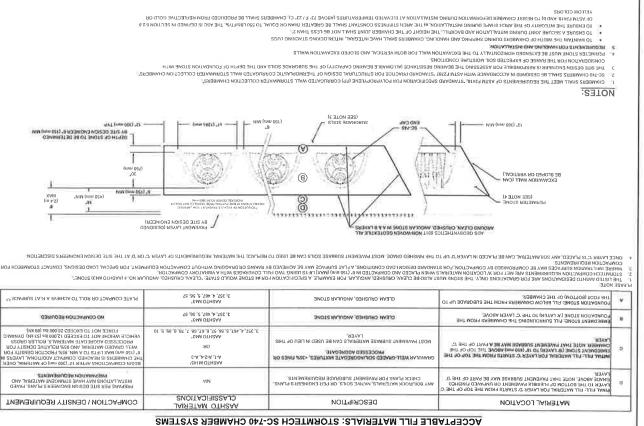

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110[11 HEET NO.:

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DATE: MAY 26, 2022

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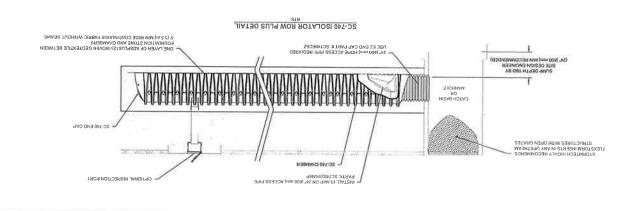
PREPARED FOR 138 BPR L

138 BOSTON POST ROAD, MAP 3

EAST LYME, CONNECTICE

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HECKED BY:



SC-740 STORMTECH CHAMBER SPECIFICATIONS



